

DEVELOPER:
WILLIAM JOHNSON CONSTRUCTION, INC.
PO BOX 1176
FLORENCE, OREGON 97439

CIVIL ENGINEER:
CLINT BEECROFT, P.E.
EGR & ASSOCIATES, INC.
2535B PRAIRIE ROAD
EUGENE, OREGON 97402
(541) 688-8322
EMAIL: clintbeecroft@egrassoc.com

INSTALLING CONTRACTOR:
RAY WELLS EXCAVATION
CONTACT: NORM WELLS
PHONE: 541-991-0938
E-MAIL: norm@raywellsinc.com

EROSION CONTROL INSPECTOR
PERMITTEE'S SITE INSPECTOR: NORM WELLS
COMPANY/AGENCY: RAY WELLS EXCAVATION
PHONE: 541-991-0938
E-MAIL: norm@raywellsinc.com
DESCRIPTION OF EXPERIENCE (BEGINNING JANUARY 1, 2017)
EROSION INSPECTORS MUST BE CERTIFIED: EROSION & SEDIMENT CONTROL INSPECTOR TRAINING, CERTIFICATE ID#ECCO-3-2072102, EXPIRES 2/7/2024

MYRTLE GLEN PUD


EROSION AND SEDIMENT CONTROL PLAN

ASSESSOR'S TAX MAP 18-12-22-11, TAX LOTS 200, 1100 AND 1200

FLORENCE, LANE COUNTY, OREGON

RESOLUTION PC 22 21 PUD 01, PC 22 23 SUB 02, & SR 22 48 SIR 13

SEPTEMBER 2023

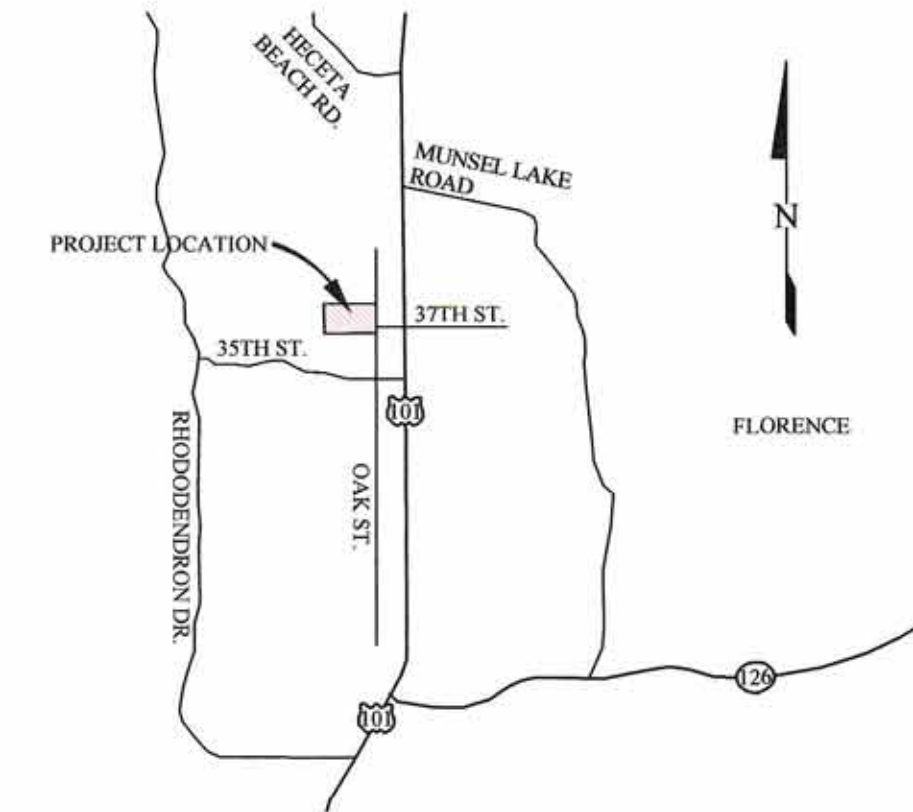

VICINITY MAP
N.T.S.

PROJECT SITE DESCRIPTION

TAX LOTS 200, 1100 AND 1200 (LANE COUNTY TAX MAP 18-12-22-11)
LATITUDE = 43.9988°, LONGITUDE = -124.1056°
WEST OF OAK STREET AT 37TH STREET INTERSECTION
FLORENCE, OREGON 97439

EXISTING SITE CONDITIONS

VACANT LAND OVERGROWN WITH COASTAL BRUSH AND TREES. A STEEP SAND DUNE IS LOCATED ALONG THE WESTERLY SIDE OF THE SITE. THERE ARE NO ON-SITE WATER WELLS OR SEPTIC SYSTEM.

DEVELOPED CONDITIONS

EXTENSION OF A PUBLIC STREET WITH UTILITIES AND 24 LOT TOWN HOUSE DEVELOPMENT WITH ASSOCIATED PRIVATE ACCESS AND UTILITIES.

NATURE OF CONSTRUCTION ACTIVITY AND FILL MATERIAL

CITY APPROVAL HAS BEEN OBTAINED TO CREATE 24 LOTS LOCATED ON TAX LOTS 200 AND 1200 FOR DEVELOPMENT OF TOWN HOMES. 37TH STREET WILL BE EXTENDED ONTO THE SITE FROM THE CURRENT INTERSECTION OF OAK STREET AND 37TH STREET TO THE EAST. TOWN HOME LOTS ARE LOCATED ON THE NORTH SIDE OF THE STREET EXTENSION. PUBLIC UTILITIES WILL BE INSTALLED AS PART OF 37TH STREET WITH UTILITY STUB-OUTS ON THE NORTH SIDE TO SERVE THE TOWN HOME LOTS. ACCESS, PARKING AND PRIVATE UTILITIES WILL BE INSTALLED BETWEEN THE STREET AND TOWN HOMES. TOWN HOMES WILL BE BUILT AS ATTACHED TRIPLEX AND FOURPLEX BUILDING UNITS. FILL MATERIAL FOR GRADING WORK WILL CONSIST OF SAND OBTAINED FROM THE SAND DUNE FORMATION ON THE WESTERLY SIDE OF THE SITE ON TAX LOT 1100. FUTURE DEVELOPMENT MAY OCCUR SOUTH OF 37TH STREET EXTENSION BUT IS NOT CURRENTLY BEING CONTEMPLATED.

TOTAL SITE AREA = 15.93 ACRES (TAX LOTS 200, 1100 AND 1200)
TOWN HOME SUBDIVISION AREA = 3.34 ACRES (TAX LOTS 200 AND 1200)
TOTAL DISTURBED AREA = 4.734 ACRES
MAXIMUM AREA TO BE DISTURBED AT ANY ONE TIME = 4.73 ACES (THE ENTIRE DISTURBED AREA WILL BE GRADED IN ONE OPERATION)

FILL MATERIAL FOR EMBANKMENT WILL CONSIST OF ON-SITE SOIL.

SITE SOIL CLASSIFICATION

TL 200: 140 YAQUINA LOAMY FINE SAND 100% OF TL MODERATE WATER EROSION HAZARD
TL 1100: 44 DUNE LAND 14% OF TL LOW WATER EROSION HAZARD
140 YAQUINA LOAMY FINE SAND 86% OF TL MODERATE WATER EROSION HAZARD
TL 1200: 140 YAQUINA LOAMY FINE SAND 100% OF TL MODERATE WATER EROSION HAZARD

SEASONAL HIGH GROUNDWATER IS ESTIMATED TO BE GREATER THAN ONE FOOT BELOW EXISTING GROUND SURFACE. THIS IS DETERMINED BASED ON NO WETLANDS ARE FOUND ON THE SITE. WETLAND HYDROLOGY REQUIRES SEASONAL HIGH GROUNDWATER TO BE PRESENT WITHIN ONE FOOT OF GROUND SURFACE.

RECEIVING WATER BODIES

THE PROJECT AREA IS SITUATED IN A CITY OF FLORENCE DRAINAGE BASIN THAT GENERALLY DRAINS SOUTHERLY AND WESTERLY VIA A SERIES OF CLOSED PIPES AND OPEN CONVEYANCES TO THE SIUSLA RIVER APPROXIMATELY TWO MILES SOUTHWESTERLY FROM THE SITE. THE SIUSLA RIVER IS NOT ON THE 303(D) LIST FOR TURBIDITY OR SEDIMENT UNDER CATEGORY 5 AND CATEGORY 4A.

NATURAL BUFFER ZONE

THERE ARE NO OFF-SITE WETLAND OR WATER BODIES WITHIN 50 FEET FROM THE SITE BOUNDARY. THERE ARE NO WETLAND OR WATER BODIES ON THE PROJECT SITE PER DSL CONCURRENCE WD#2021-0494 OF WETLAND DELINEATION REPORT PREPARED BY PACIFIC HABITAT SERVICES INC. THE NATURAL BUFFER ZONE REQUIREMENTS ARE MET.

ENGINEERED SOILS

ENGINEERED SOILS (SOIL AMENDMENTS INCLUDING, BUT NOT LIMITED TO PORTLAND CEMENT-TREATED BASE, CEMENT KILN DUST, OR FLY ASH) WILL NOT BE UTILIZED ON THIS SITE.

CONSTRUCTION SUPPORT ACTIVITIES

THERE ARE NO PROPOSED OFF-SITE CONSTRUCTION SUPPORT ACTIVITIES. ON-SITE CONTRACTOR STAGING AREAS ARE SHOWN ON THE SITE PLANS.

ENVIRONMENTAL MANAGEMENT PLAN

THERE ARE NO KNOWN CONTAMINATED SOILS, CONTAMINATED GROUNDWATER, OR HAZARDOUS MATERIALS ON THE SITE. THERE IS NO ACTIVE TREATMENT SYSTEM FOR SEDIMENT, pH NEUTRALIZATION, OR OTHER POLLUTANT REMOVAL PLANNED OR TO BE IMPLEMENTED AT THE PROJECT SITE.


1200C PERMIT COMPLIANCE

THE PERMITTEE IS REQUIRED TO MEET ALL THE CONDITIONS OF THE 1200C PERMIT. THIS ESCP AND GENERAL CONDITIONS HAVE BEEN DEVELOPED TO FACILITATE COMPLIANCE WITH THE 1200C PERMIT REQUIREMENTS. IN CASES OF DISCREPANCIES OR OMISSIONS, THE 1200C PERMIT REQUIREMENTS SUPERCEDE REQUIREMENTS OF THIS PLAN.

UTILITY LOCATES

ATTENTION: OREGON LAW REQUIRES YOU TO FOLLOW RULES ADOPTED BY THE OREGON UTILITY NOTIFICATION CENTER. THOSE RULES ARE SET FORTH IN OAR 952-001-0001 THROUGH 952-001-0100. YOU MAY OBTAIN COPIES OF THE RULES BY CALLING THE CENTER. NOTE: THE TELEPHONE NUMBER FOR THE OREGON UTILITY NOTIFICATION CENTER IS (503) 232-1987.

TO REQUEST A LOCATE PLEASE
CALL: 811 OR (800) 332-2344

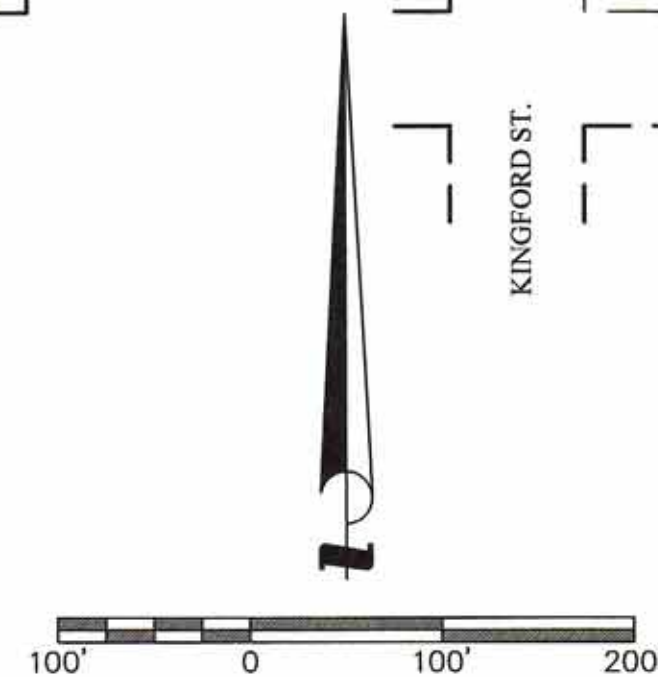

SITE CONTRACTOR INFORMATION

(NOTE: REVISE AS APPROPRIATE UNTIL PERMIT COVERAGE IS TERMINATED)

INSTALLING CONTRACTOR

INSTALLING CONTRACTOR IS RAY WELLS EXCAVATION RESPONSIBLE FOR ALL SITE PREPARATION, UNDERGROUND UTILITIES, STREET CONSTRUCTION, AND INSTALLATION AND MAINTENANCE OF EROSION CONTROL BMPs.

RESPONSIBLE PERSON: NORM WELLS (541) 991-0938

EROSION CONTROL INSPECTOR

VISUAL MONITORING OF EROSION CONTROL BEST MANAGEMENT PRACTICES.

RESPONSIBLE PERSON: NORM WELLS (541) 991-0938

SUB-CONTRACTORS

CONCRETE WORK: TO BE DETERMINED

ASPHALT CONCRETE PAVING: TO BE DETERMINED

LANDSCAPE INSTALLER: TO BE DETERMINED

GENERAL CONTRACTOR

GENERAL CONTRACTOR IS WILLIAM JOHNSON CONSTRUCTION RESPONSIBLE FOR ERECTING THE TOWNHOUSES.

RESPONSIBLE PERSON IS: WILLIAM JOHNSON (541) 999-0836

CONSTRUCTION SCHEDULE

CONSTRUCTION IS DIVIDED INTO PHASES CONSISTING OF CLEARING, SITE GRADING, PUBLIC IMPROVEMENTS, PRIVATE IMPROVEMENTS, VERTICAL CONSTRUCTION AND FINAL STABILIZATION. PUBLIC IMPROVEMENTS INCLUDE SITE GRADING AND EXTENSION OF 37TH STREET AND ASSOCIATED PUBLIC UTILITIES. PRIVATE IMPROVEMENTS INCLUDE INSTALLATION OF PRIVATE UTILITIES, ACCESS, PARKING AREAS AND VERTICAL CONSTRUCTION OF THE TOWNHOUSE TRIPLEX AND FOURPLEX UNITS.

WORK TO INSTALL PUBLIC IMPROVEMENTS WILL COMMENCE UPON CITY OF FLORENCE PUBLIC WORKS PLAN APPROVALS AND ISSUANCE OF A DEQ EROSION CONTROL PERMIT. WORK ACTIVITIES WILL BE CONTINUOUS WITH AN EXPECTED SEVEN MONTH DURATION FROM START OF SITE DISTURBANCE.

WORK TO INSTALL PRIVATE IMPROVEMENTS WILL COMMENCE UPON ISSUANCE OF CITY BUILDING PERMITS AND A DEQ EROSION CONTROL PERMIT. BUILDING CONSTRUCTION WILL PROGRESS FROM EAST TO WEST. PRIVATE UTILITIES WILL BE INSTALLED AS BUILDING CONSTRUCTION PROGRESSES. THE DURATION OF BUILDING CONSTRUCTION IS DEPENDENT UPON MARKET DEMAND FOR FINISHED TOWNHOUSE UNITS. THE GENERALIZED CONSTRUCTION SCHEDULE ASSUMES A 12 MONTH DURATION, BUT BUILDING DURATION COULD BE LONGER.

WORK DAYS/HOURS IS TYPICALLY MONDAY THROUGH FRIDAY BETWEEN 7:00 AM AND 5:00 PM.

| GENERALIZED CONSTRUCTION SCHEDULE | | |
|--|----------|----------|
| DATES ARE ESTIMATES ONLY | | |
| TASK | START | END |
| INSTALL PERIMETER EROSION CONTROL BMPs | OCT 2023 | ONGOING |
| CLEARING AND SITE GRADING | OCT 2023 | DEC 2023 |
| INSTALL UNDERGROUND PUBLIC UTILITIES | DEC 2023 | JAN 2024 |
| INSTALL BASE ROCK AND CONCRETE CURBS | JAN 2024 | FEB 2024 |
| INSTALL STORMWATER SWALES AND PIPING | FEB 2024 | MAR 2024 |
| INSTALL FINAL BASE ROCK AND PAVING | FEB 2024 | MAR 2024 |
| INSTALL SIDEWALKS AND RAMPS | MAR 2024 | APR 2024 |
| TOWNHOUSE CONSTRUCTION | JAN 2024 | DEC 2024 |
| INSTALL PRIVATE UTILITIES/PAVING | JAN 2024 | DEC 2024 |
| FINAL SITE STABILIZATION | ONGOING | DEC 2024 |

POLLUTANT-GENERATING ACTIVITIES (4.4.E.XIII)

| ID | ACTIVITY | INVENTORY OF POLLUTANTS |
|----|--|--|
| A | SITE GRADING (REMOVAL AND FILL OPERATIONS) | SEDIMENT AND DUST |
| B | SANITARY AND DOMESTIC WASTE STORAGE | SOLID AND SANITARY WASTE |
| C | EQUIPMENT MAINTENANCE* | OIL AND GREASE |
| D | PORTLAND CEMENT CONCRETE PLACEMENT | SUSPENDED SOLIDS, HEAVY METALS, PH INCREASES |
| E | AGGREGATE PLACEMENT | SEDIMENT |
| F | ASPHALT CONCRETE PLACEMENT | HYDROCARBONS, OILS AND GREASES, HEAVY METALS |

NOTE: THE USE OF PESTICIDES, HERBICIDES, INSECTICIDES, AND FERTILIZERS IS NOT ANTICIPATED ON THIS PROJECT.

C* LIQUIDS SUCH AS FUEL WILL NOT BE STORED ON SITE. EQUIPMENT FUELING AND SERVICING ACTIVITIES WILL BE PROVIDED BY MOBILE VEHICLES THAT ARE LOCATED OFF-SITE. THESE ACTIVITIES WILL OCCUR ON HARD SURFACES. DRIP PADS AND SPILL KITS ARE AVAILABLE IN SERVICE VEHICLES.

AUTHORIZED NON-STORMWATER DISCHARGES (4.4.E.XII)

| ID | DISCHARGE ACTIVITY |
|----|---|
| G | WATER USED TO CONTROL DUST |
| H | FIRE HYDRANT FLUSHING |
| I | POTABLE WATER INCLUDING UNCONTAMINATED WATER LINE FLUSHINGS |
| J | CONSTRUCTION DEWATERING ACTIVITIES* |


J* CONSTRUCTION DEWATERING IS NOT ANTICIPATED.

WEATHER REPORT NOTE:
NEAREST OFFICIAL RAIN GAUGE THAT WILL BE USED FOR SITE MONITORING IS AT THE FLORENCE MUNICIPAL AIRPORT.
www.weather.gov/wrh/timeseries?site=K652

SHEET INDEX

EROSION AND SEDIMENT CONTROL PLAN

- EC 1 COVER SHEET AND SITE MAP
- EC 2 STANDARD NOTES AND BMPs
- EC 3 EXISTING SITE CONDITIONS
- EC 4 CLEARING AND SITE GRADING
- EC 5 STREET AND UTILITIES
- EC 6 VERTICAL CONSTRUCTION
- EC 7 FINAL SITE STABILIZATION
- EC 8 STANDARD DRAWINGS AND DETAILS

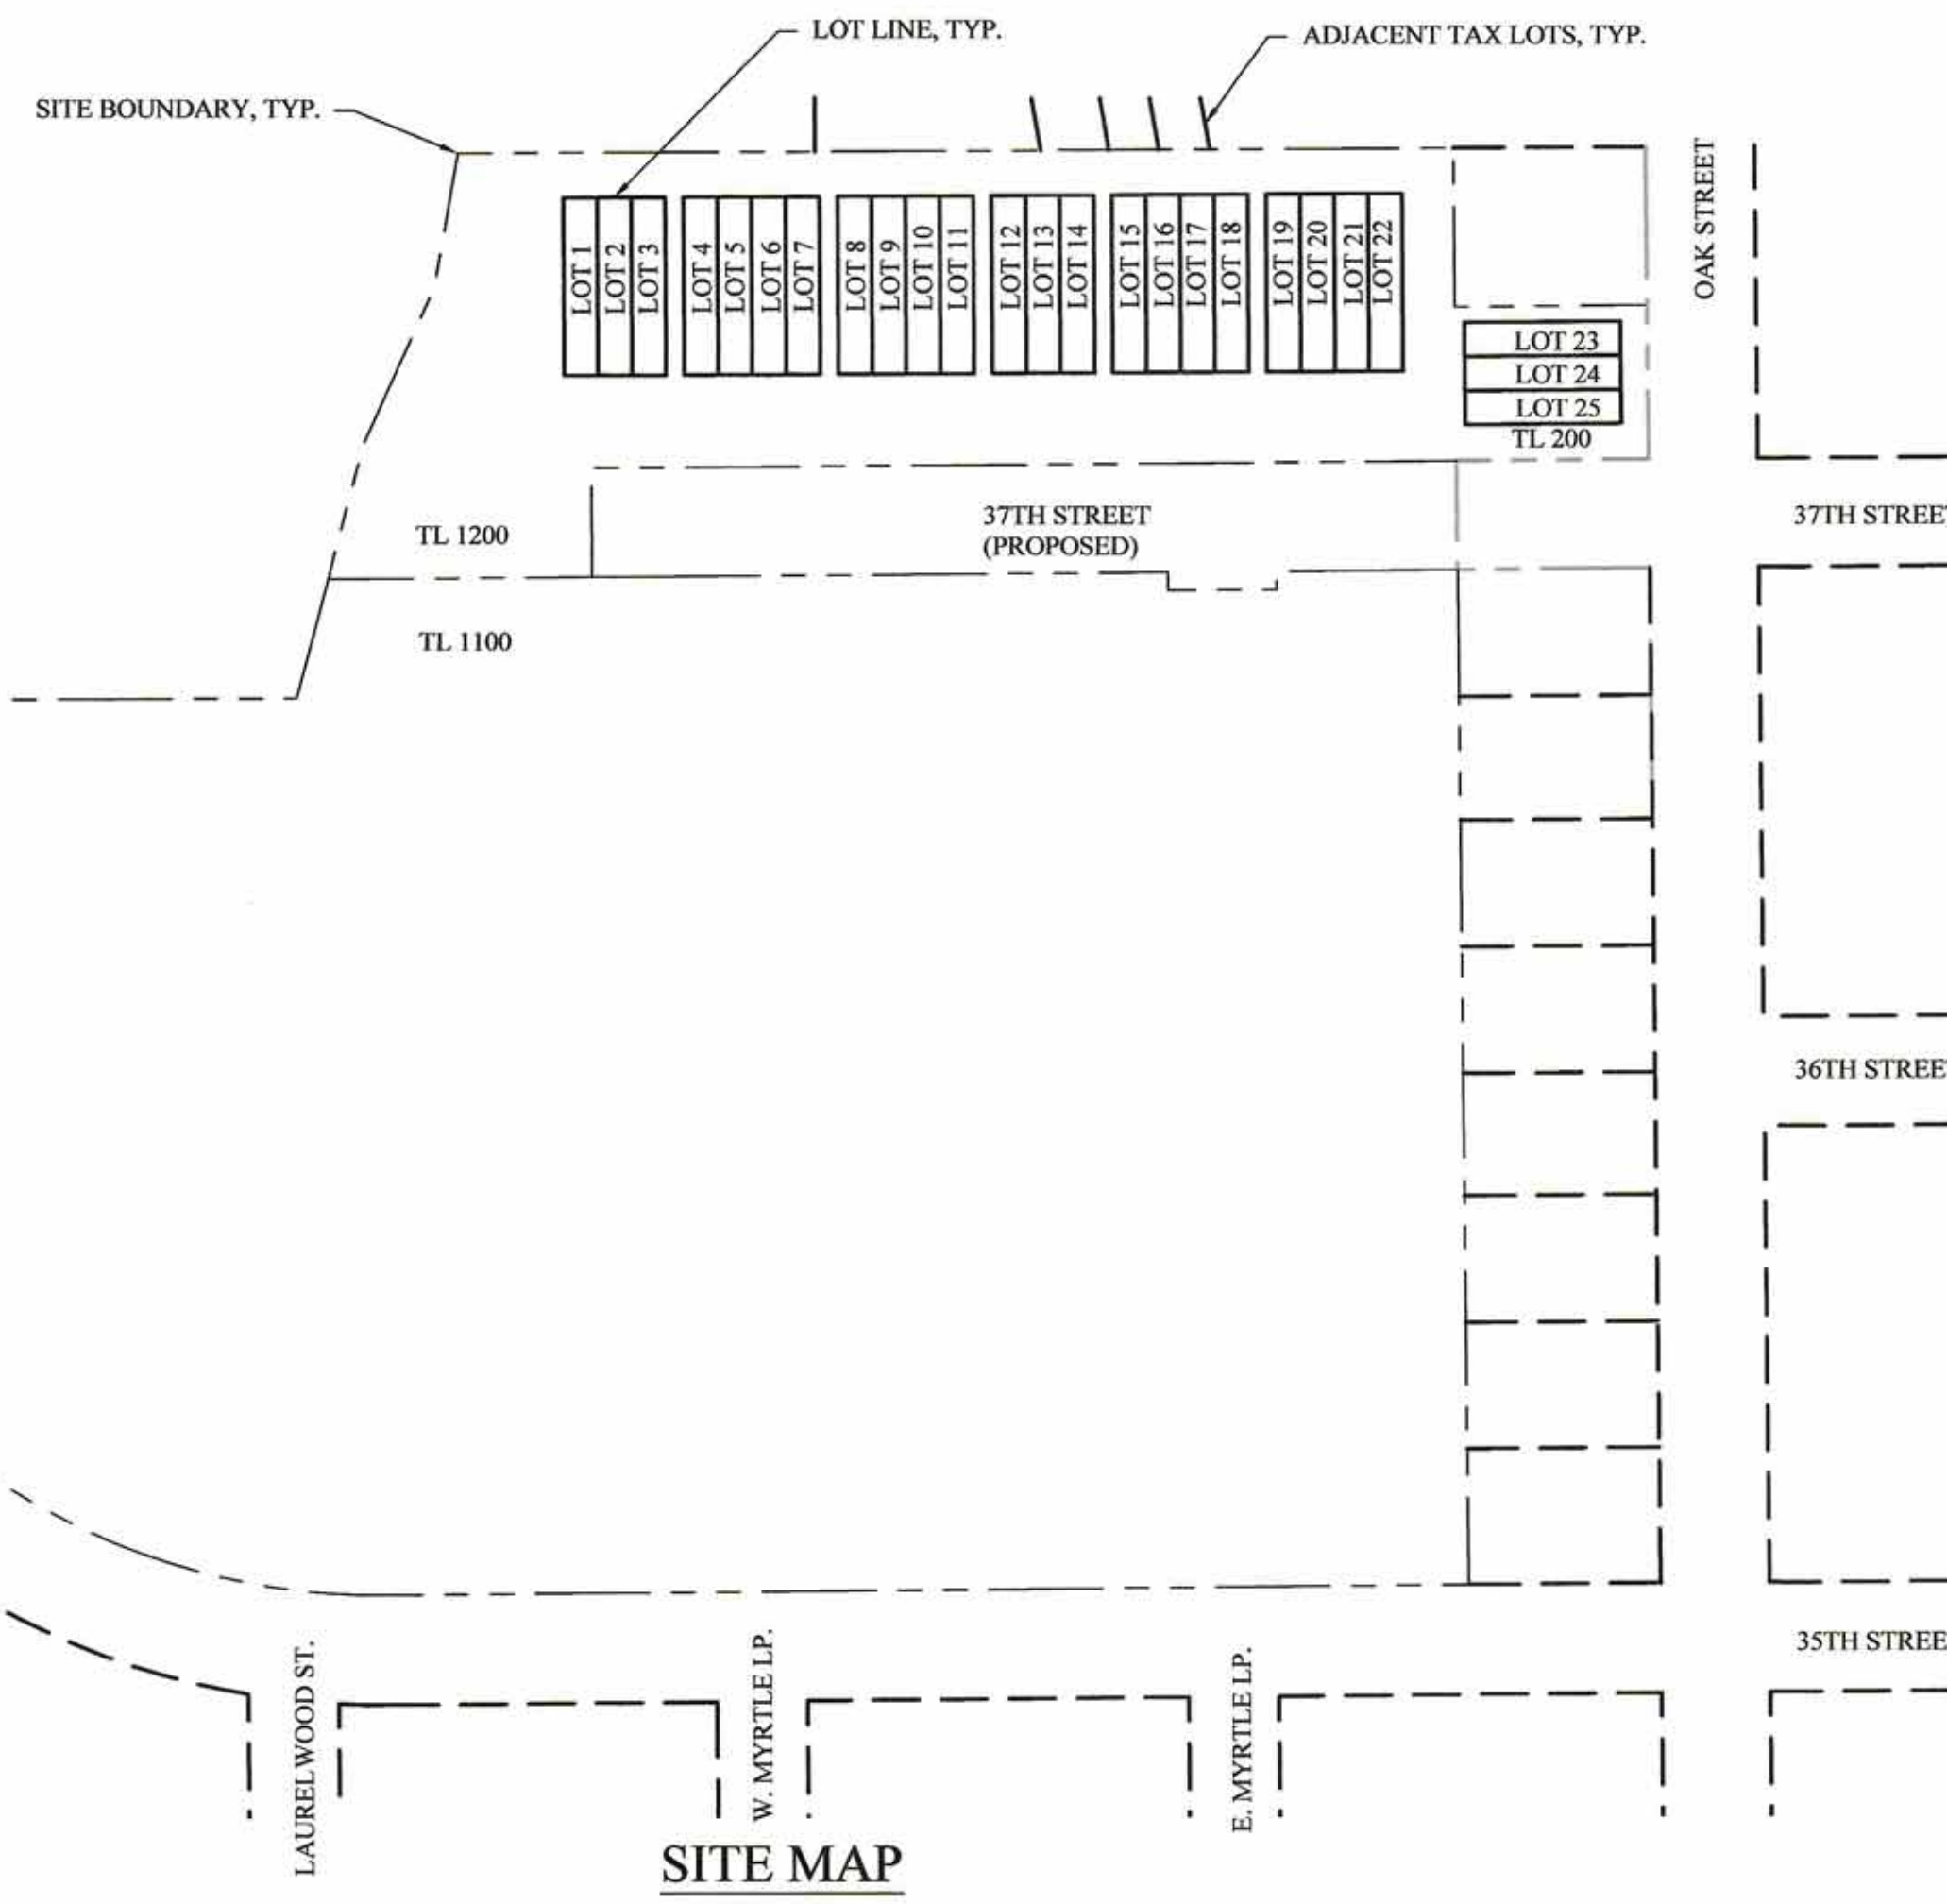

ECR & Associates, Inc.
Engineers and Surveyors
2535B Prairie Road
Eugene, Oregon 97402
(541) 688-8322
Fax: (541) 688-8087



MYRTLE GLEN PUD
FINAL PUD IMPROVEMENT DRAWINGS
EROSION AND SEDIMENT CONTROL
COVER SHEET AND SITE MAP
FLORENCE, OREGON

| Date | Description of Revisions | No | Name |
|------------|--------------------------|----|-------------|
| 09-25-2023 | 7091-22-0187 | | C. BEECROFT |
| | | | C. BEECROFT |
| | | | C. BEECROFT |

Job Number: 7091-22-0187
Design by: C. BEECROFT
Drawn by: C. BEECROFT
Checked by: C. BEECROFT

Sheet Number: EC1

CONSTRUCTION NOTES

- 1 EXISTING STORMWATER MANHOLE. THE ON-SITE STORMWATER INFILTRATION FACILITIES WILL HAVE INTERCONNECTED OVERFLOW STANDPIPES THAT WILL DISCHARGE TO THE EXISTING STORMWATER MANHOLE.
- 2 EXISTING WASTEWATER MANHOLE CONNECTION POINT.
- 3 EXISTING STORMWATER INLET AND CURB WILL BE REMOVED WHEN NEW STORMWATER INLET AND CURB ARE INSTALLED.


UTILITY STATEMENT:
 THE UNDERGROUND UTILITIES SHOWN HAVE BEEN LOCATED FROM FIELD SURVEY INFORMATION AND EXISTING DRAWINGS. THE SURVEYOR MAKES NO GUARANTEE THAT THE UNDERGROUND UTILITIES SHOWN COMPRISE ALL SUCH UTILITIES IN THE AREA, EITHER IN SERVICE OR ABANDONED. THE SURVEYOR FURTHER DOES NOT WARRANT THAT THE UNDERGROUND UTILITIES SHOWN ARE IN THE EXACT LOCATION INDICATED ALTHOUGH HE DOES CERTIFY THAT THEY ARE LOCATED AS ACCURATELY AS POSSIBLE FROM THE INFORMATION AVAILABLE. THE SURVEYOR HAS NOT PHYSICALLY LOCATED THE UNDERGROUND UTILITIES

STORMWATER NOTE

THERE ARE NO DEFINED SURFACE WATER CHANNELS LOCATED ON THE PROJECT SITE. NONE OF THE ADJACENT LANDS NATURALLY FLOW SURFACE WATER ONTO OR AWAY FROM THE SITE. SINCE NEARLY THE ENTIRE PROJECT SITE IS LOCATED ON SANDY SOIL, SURFACE WATER DOES NOT FLOW OFF THE PROJECT AREA. INSTEAD, THE SURFACE WATER ALMOST IMMEDIATELY INFILTRATES INTO THE SAND AND IS INTEGRATED INTO THE GROUNDWATER SYSTEM.


LEGEND

- ⊕ WASTEWATER MANHOLE
- STORMWATER INLET
- - - - DITCH
- - - E - - - POWER LINE
- - - ww - - - WASTEWATER PIPE
- - - W - - - WATER PIPE
- - - ST - - - STORM PIPE
- - - T - - - COMMUNICATIONS LINE
- GROUND SURFACE SLOPE DIRECTION

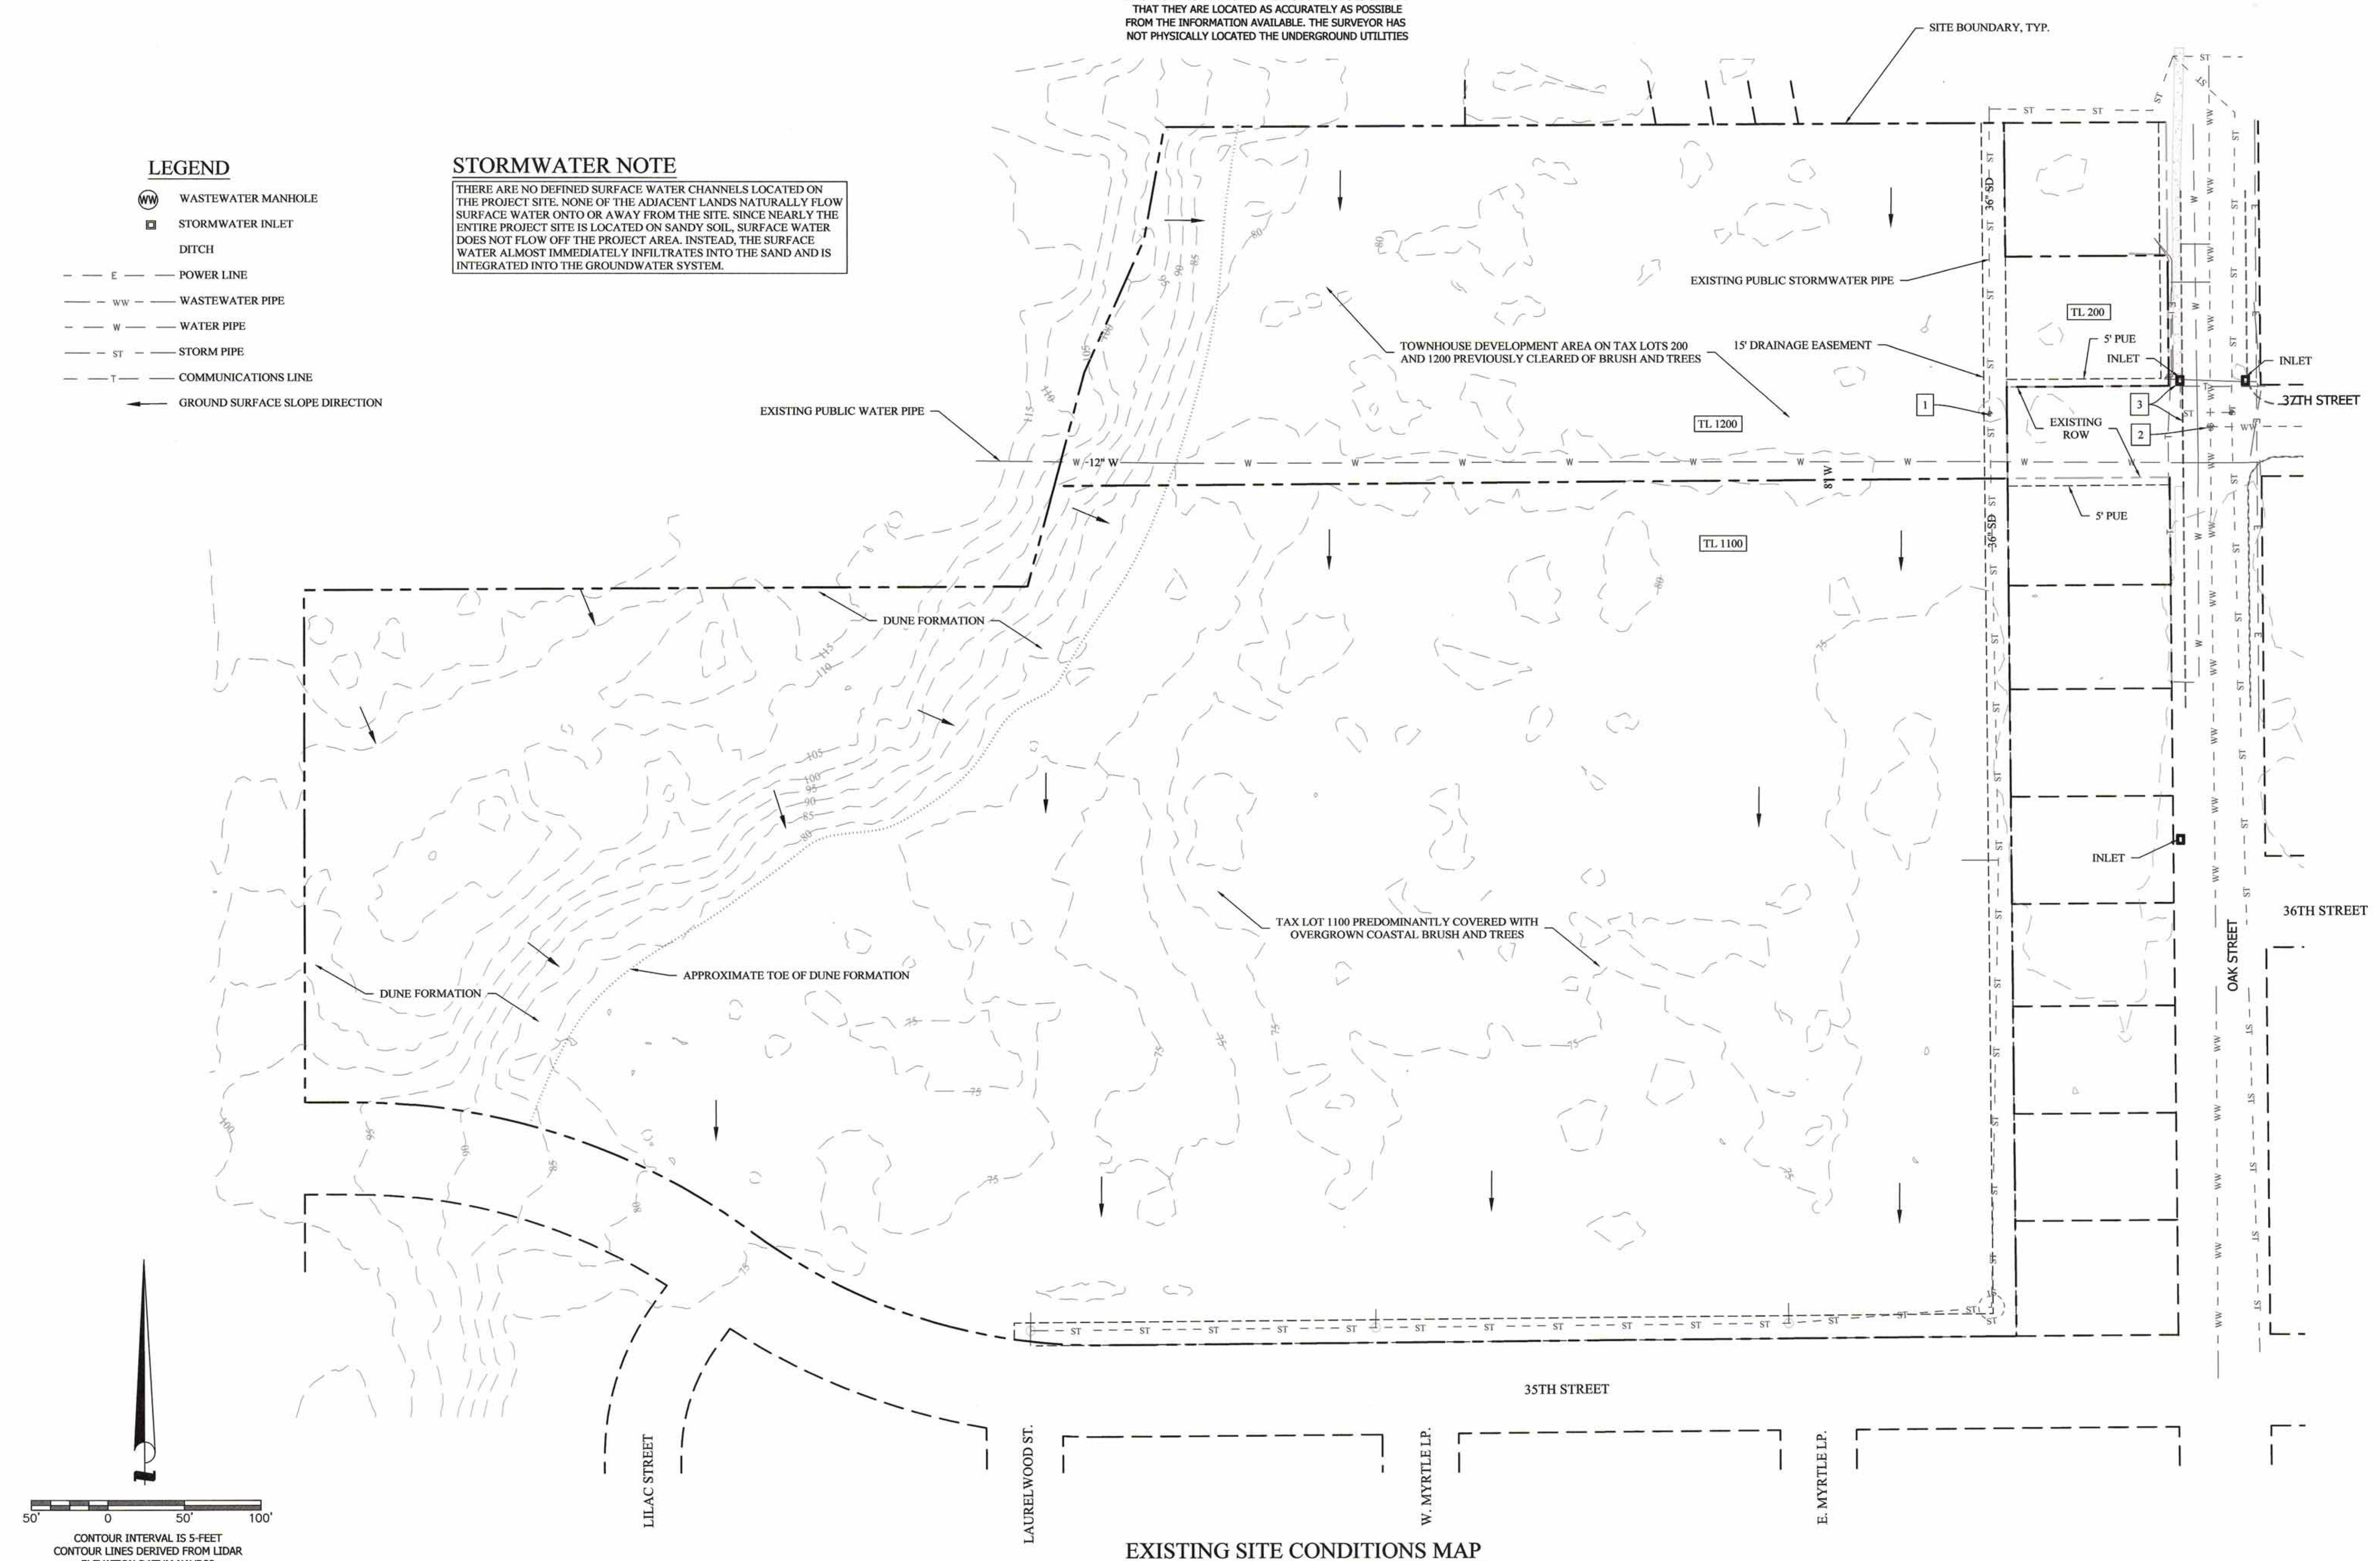

EXISTING SITE CONDITIONS MAP

1" = 50'

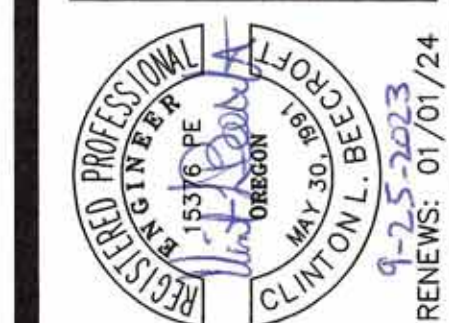

MYRTLE GLEN PUD
FINAL PUD IMPROVEMENT DRAWINGS
EROSION AND SEDIMENT CONTROL
EXISTING SITE CONDITIONS
 FLORENCE, OREGON

| Date | Description of Revisions | No | Name |
|------------|--------------------------|----|------|
| 09-25-2023 | 7091-22-0187 | | |
| | C. BEECROFT | | |
| | C. BEECROFT | | |
| | C. BEECROFT | | |

Sheet Number

EC3

Plot Date: Sep 25, 2023 11:14 AM
 Plot File: S:\Projects\17091 Myr. Johnson\22-0187 37th Street\Phase 1 PUD\Sheets\22-0187 Erosion Control.dwg LAYOUT=EC3

CONSTRUCTION NOTES

1. CONSTRUCT INLET PROTECTION PER FLORENCE DETAIL F-105
2. CONSTRUCT CONSTRUCTION ENTRANCE - TYPE 1 PER OREGON STD DWG RD1000
3. CONSTRUCT SILT FENCE SEDIMENT BARRIER PER FLORENCE DETAIL F-101
4. PORTABLE SANITARY FACILITY AND TRASH BIN WITH LID
5. INSTALL ORANGE CONSTRUCTION FENCE TO PROTECT EXISTING VEGETATION
6. PRESERVE EXISTING VEGETATION OUTSIDE WORK ZONES

CLEARING AND GRADING PHASE INFORMATION

1. SOIL FILL MATERIAL WILL CONSIST OF ON-SITE SAND EXCAVATED FROM THE DUNE FORMATION. APPROXIMATELY 10,000 CUBIC YARDS OF IN-PLACE FILL IS NEEDED.
2. DEVELOP THE SAND BORROW AREA BY CLEARING VEGETATION FROM THE BORROW SITE AND A 30-FOOT WIDE HAUL ROUTE FROM THE BORROW SITE TO THE DEVELOPMENT AREA.
3. TEMPORARILY STABILIZE EXPOSED SOILS IN THE BORROW AREA WHEN INACTIVE FOR 14 OR MORE CALENDAR DAYS WITH SEEDING, MULCH, MATS, PLASTIC SHEETING, OR ROCK AS NEEDED. PERMANENT SLOPES IN THE BORROW AREA SHALL BE NO STEEPER THAN 2:1 AND SHALL BE PROTECTED WITH EROSION CONTROL MEASURES.
4. CLEAR THE DEVELOPMENT AREA OF VEGETATION AND ORGANIC MATERIAL PRIOR TO FILL PLACEMENT. FILL MATERIAL SHALL BE FREE OF ORGANICS OR OTHER DELETERIOUS MATERIALS. THE FILL SHALL BE MOISTURE CONDITIONED WITHIN +/-2-PERCENT OF OPTIMUM MOISTURE CONTENT AND COMPACTED IN LIFTS USING APPROPRIATE EQUIPMENT WITH LOOSE LIFT THICKNESS NOT EXCEEDING 8-INCHES. COMPACT FILL MATERIAL TO MINIMUM 90% OF ASHTO T-180/ASTM 1557-D.

NON-STORMWATER CONTROLS


1. ESTABLISH MATERIAL AND WASTE STORAGE AREA, AND OTHER NON-STORMWATER CONTROLS BEFORE CONSTRUCTION ACTIVITIES COMMENCE.
2. PROVIDE WASTE CONTAINERS (E.G., DUMPSTER, TRASH RECEPTACLE) THAT PROVIDE GROUND SEPARATION AND ARE SUFFICIENT SIZE AND NUMBER TO CONTAIN CONSTRUCTION AND DOMESTIC WASTES.
3. POSITION PORTABLE TOILETS SO THAT THEY ARE SECURE AND WILL NOT BE TIPPED OR KNOCKED OVER, AND LOCATED AWAY FROM WATERS OF THE STATE AND STORMWATER INLETS OR CONVEYANCES.

EROSION CONTROL LEGEND

- APPROXIMATE LIMITS OF DISTURBANCE
- SILT FENCE SEDIMENT BARRIER
- +—+— ORANGE CONSTRUCTION FENCE
- ▨ CONSTRUCTION ENTRANCE
- (A) LOCATION OF POLLUTANT-GENERATING ACTIVITIES AND AUTHORIZED NON-STORMWATER DISCHARGES (SEE TABLES ON SHEET EC1 FOR DESCRIPTIONS)

STORMWATER CONTROLS

1. INSTALL PERIMETER CONTROLS CONSISTING OF SILT FENCES, CONSTRUCTION ENTRANCE AND INLET PROTECTION AT THE BEGINNING OF CONSTRUCTION AND MAINTAIN FOR THE DURATION OF THE PROJECT.
2. COMPLETE THE INSTALLATION OF STORMWATER CONTROLS BEFORE EACH PHASE OF CONSTRUCTION ACTIVITIES BEGIN AS FOLLOWS:
 - A. INSTALL AND IMPLEMENT ANY DOWNGRADIENT SEDIMENT CONTROLS (E.G. BUFFERS, PERIMETER CONTROLS, DISCHARGE POINT CONTROLS, STORM DRAIN INLET PROTECTION) BEFORE CONSTRUCTION ACTIVITY IN ANY PORTION OF THE SITE BEGINS;
 - B. INSTALL EROSION PREVENTION MEASURES (E.G. MATTING, STRAW MULCH, COMPOST BLANKETS) ON CLEARED AREAS THAT WILL NOT BE WORKED FOR 14 DAYS; AND
 - C. FOLLOWING THE INSTALLATION OF STORMWATER CONTROLS FOR INITIAL CONSTRUCTION ACTIVITIES ADJUST STORMWATER CONTROLS AND MANAGEMENT STRATEGIES THROUGHOUT THE PROJECT SITE TO MEET AND MATCH THE NEEDS OF EACH PHASE OF CONSTRUCTION AS THE PROJECT IS IMPLEMENTED.
2. WHERE SEDIMENT HAS BEEN TRACKED-OUT FROM THE SITE ONTO THE PAVED ROADS OUTSIDE OF THE SITE, REMOVE THE SEDIMENT BY THE END OF THE SAME BUSINESS DAY THAT THE TRACK-OUT OCCURS OR BY THE END OF THE NEXT BUSINESS DAY IF TRACK-OUT OCCURS ON A NON-BUSINESS DAY. TRACK-OUT MUST BE REMOVED BY SWEEPING, SHOVELING, OR VACUUMING THESE SURFACES, OR BY USING OTHER SIMILARLY EFFECTIVE MEANS OF SEDIMENT REMOVAL. HOSING OR SWEEPING TRACKED-OUT SEDIMENT INTO THE ADJACENT STORMWATER CONVEYANCES OR STORM DRAIN INLET IS PROHIBITED.
3. PREVENT WIND-BLOWN SOIL AND DUST FROM AREAS WITH EXPOSED SOIL THROUGH THE APPROPRIATE APPLICATION OF WATER OR OTHER DUST SUPPRESSION TECHNIQUES TO CONTROL THE GENERATION OF POLLUTANTS THAT COULD BE DISCHARGED IN STORMWATER FROM THE SITE.
4. INITIATE THE INSTALLATION OF TEMPORARY STABILIZATION MEASURES OR PERMANENT STABILIZATION MEASURES IMMEDIATELY WHENEVER ANY LAND DISTURBING ACTIVITIES HAVE PERMANENTLY CEASED OR WILL BE TEMPORARILY INACTIVE ON ANY PORTION OF THE SITE FOR 14 OR MORE CALENDAR DAYS.
5. TEMPORARY SLOPE STABILIZATION MEASURES SHALL INCLUDE COVERING EXPOSED SOIL WITH PLASTIC SHEETING, STRAW MULCHING, OR OTHER APPROVED METHODS.
6. LOCATE STOCKPILES AWAY FROM CONSTRUCTION ACTIVITIES THAT CONTAIN SEDIMENT OR SOIL.
7. STOCKPILED TOPSOIL, STRIPPING AND IMPORTED FILL MATERIAL SHALL BE PLACED IN A STABLE CONFIGURATION. DURING WET WEATHER PERIODS, STOCKPILES SHALL BE COVERED WITH PLASTIC SHEETING. SEDIMENT BARRIER IS REQUIRED AROUND THE PERIMETER OF THE STOCKPILE.

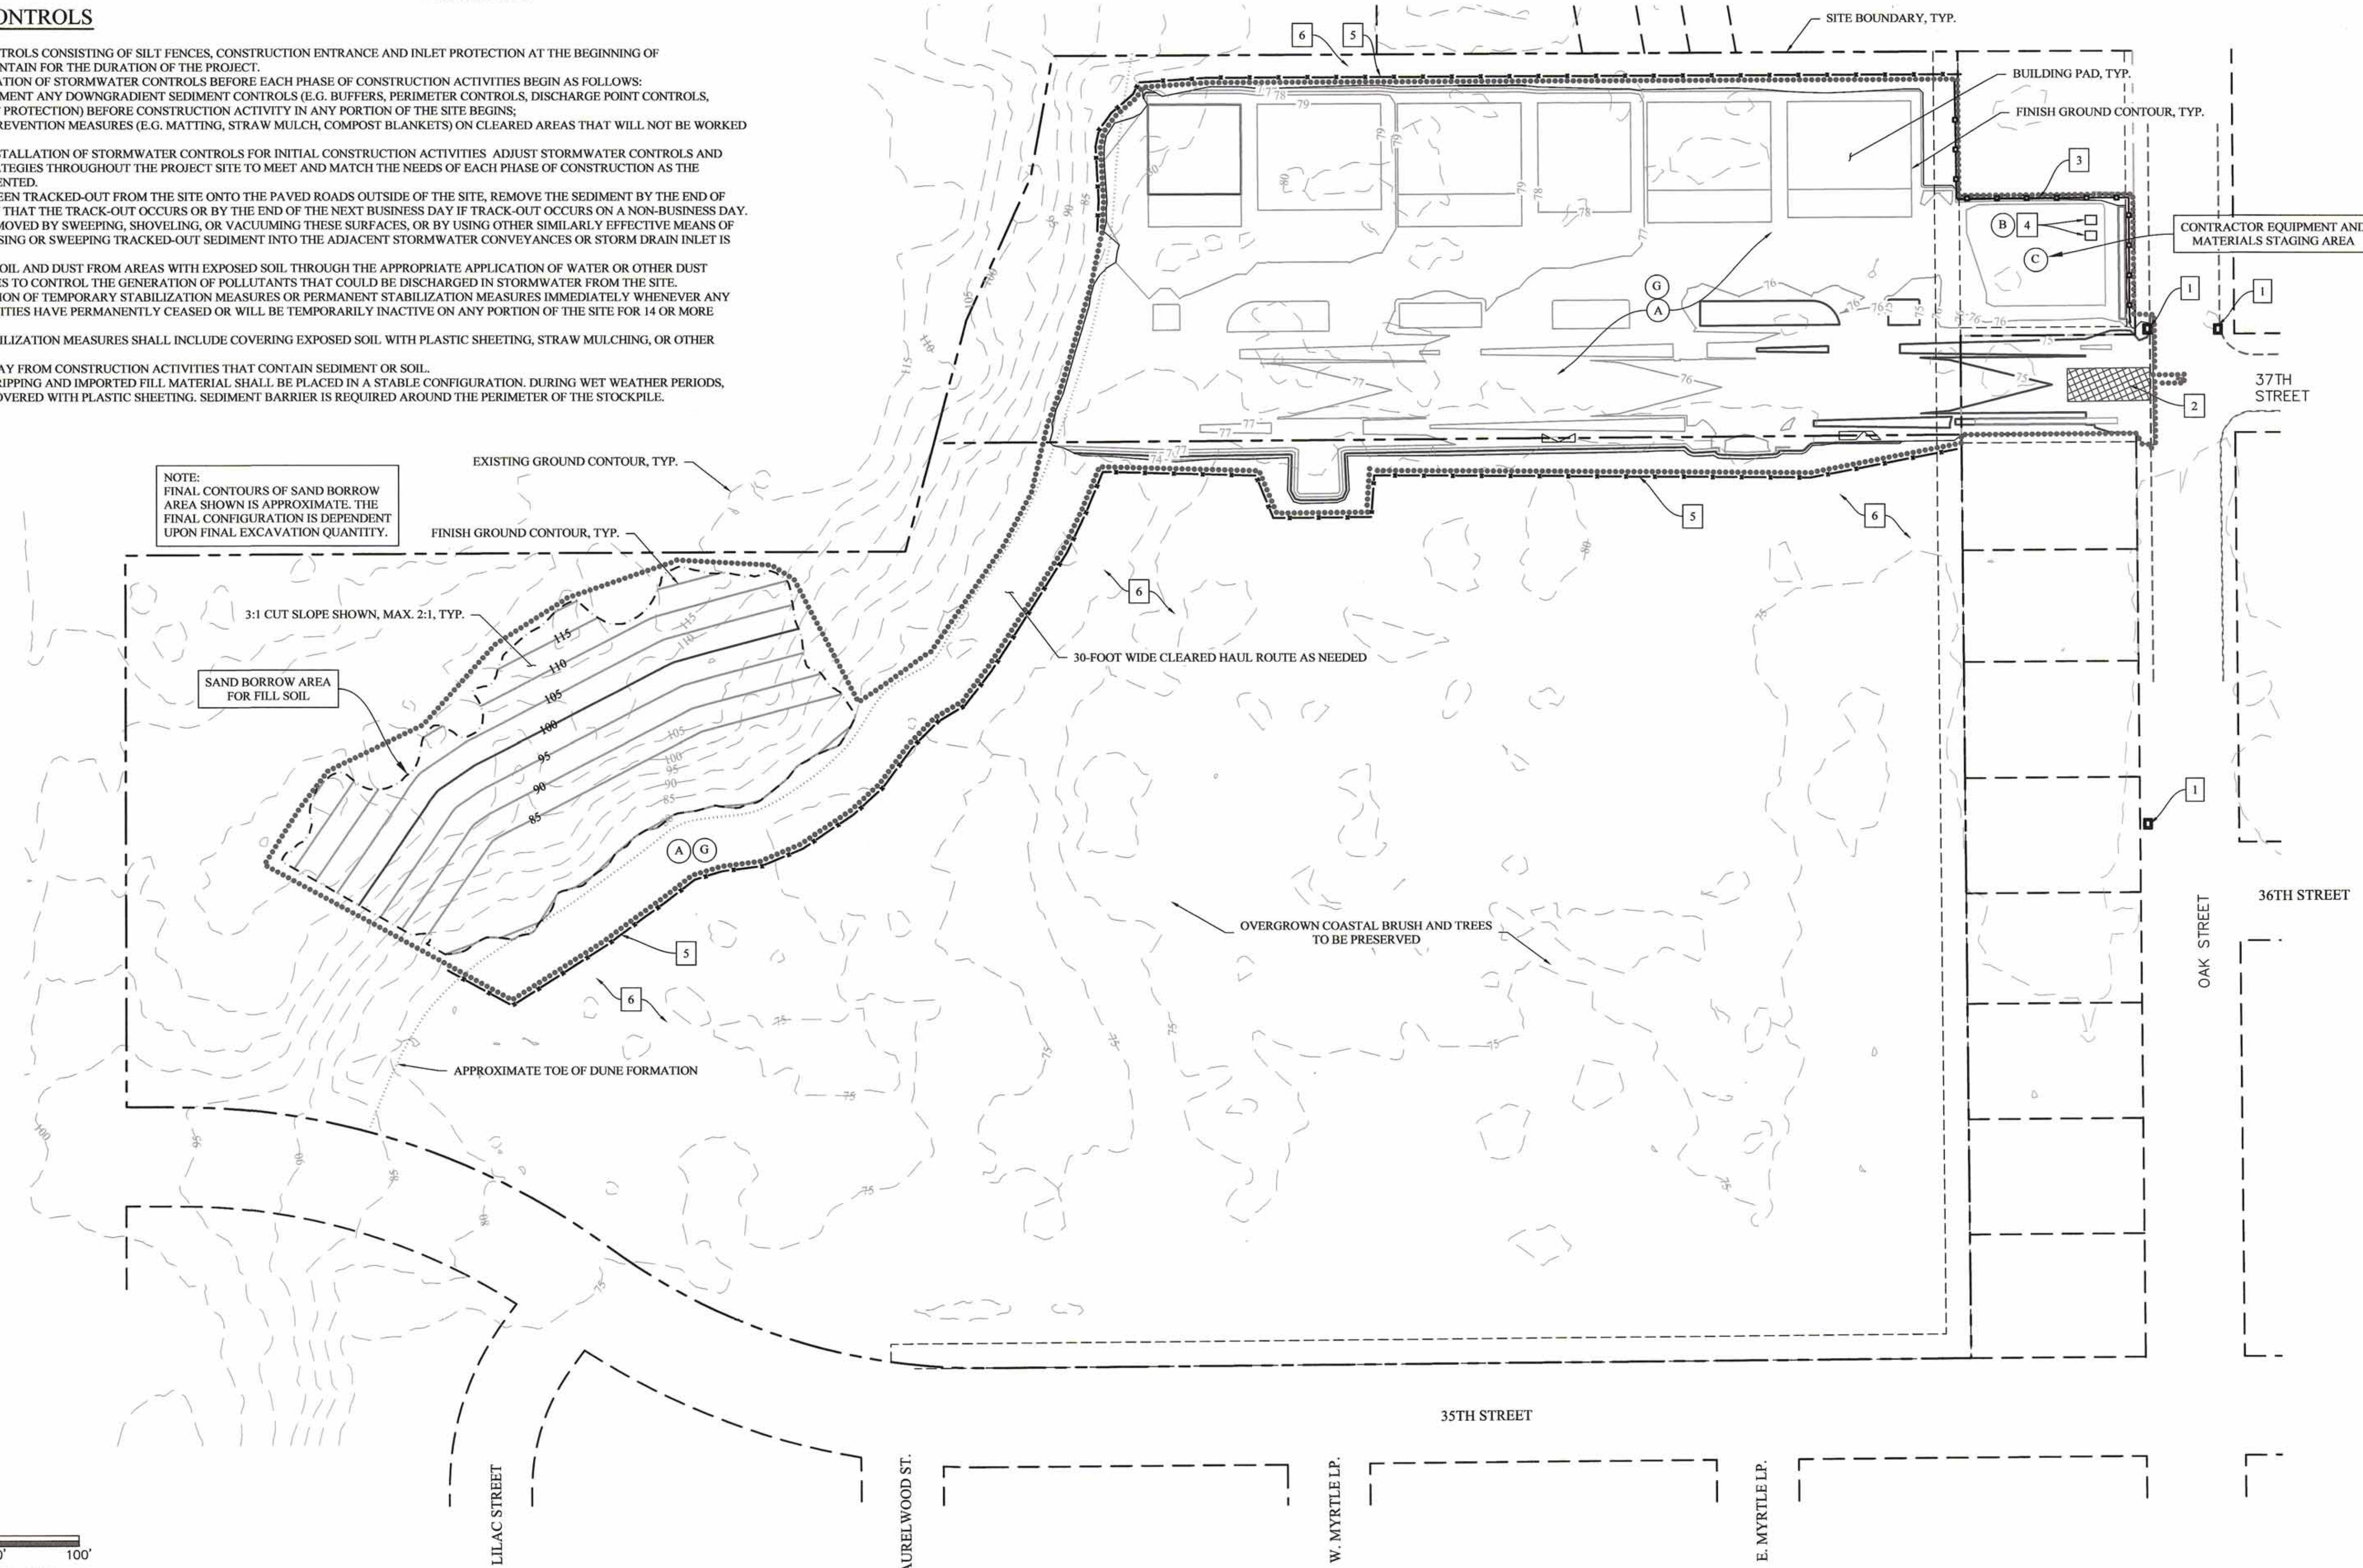

CLEARING AND GRADING PLAN
1" = 50'

ECR & Associates, Inc.
Engineers and Surveyors

2535B Prairie Road
Eugene, Oregon 97402

(541) 688-8322
Fax (541) 688-8087

REGISTERED PROFESSIONAL ENGINEER
STATE OF OREGON
NO. 15316 PE
9-23-2023
CLINTON L. BEECROFT
RENEWALS: 01/01/24

MYRTLE GLEN PUD
FINAL PUD IMPROVEMENT DRAWINGS
EROSION AND SEDIMENT CONTROL
CLEARING AND SITE GRADING
FLORENCE, OREGON

| No | Description of Revisions | Date | Name |
|----|--------------------------|------|------|
| | | | |
| | | | |
| | | | |
| | | | |
| | | | |

| | |
|------------|--------------|
| Date | 09-25-2023 |
| Job Number | 7091-22-0187 |
| Design by | C. BEECROFT |
| Drawn by | C. BEECROFT |
| Checked by | C. BEECROFT |

Sheet Number
EC4

Plot Date: 09-25-2023 11:03am
S:\Projects\7091 Mike Johnson\22-0187 37th Street\Phase 1\PE\15\Sheet\22-0187-Erosion Control.dwg LAYOUT-EC4

CONSTRUCTION NOTES

- 1 MAINTAIN INLET PROTECTION THROUGHOUT CONSTRUCTION DURATION, UNLESS INLET IS REMOVED
- 2 MAINTAIN CONSTRUCTION ENTRANCE UNTIL BASE ROCK OR PAVEMENT IS PLACED
- 3 MAINTAIN SILT FENCE SEDIMENT BARRIER THROUGHOUT CONSTRUCTION DURATION
- 4 PORTABLE SANITARY FACILITY AND TRASH BIN WITH LID
- 5 MAINTAIN ORANGE CONSTRUCTION FENCE TO PROTECT EXISTING VEGETATION
- 6 PRESERVE EXISTING VEGETATION OUTSIDE WORK ZONES
- 7 CONSTRUCT INLET PROTECTION PER FLORENCE DETAIL F-105 WHEN NEW INLET IS INSTALLED
- 8 CONSTRUCT CONCRETE WASHOUT PER STD DWG RD1070 (LOCATION TO BE DETERMINED BY INSTALLING CONTRACTOR)
- 9 CONSTRUCT OUTLET PROTECTION AT END OF ROOF DRAIN PIPES THAT DISCHARGES INTO RAIN GARDEN CONSISTING OF 18"X18"X4" PRECAST CONCRETE SPLASH PAD SURROUNDED BY COMPOST FILTER SOCK OR BIOFILTER BAGS
- 10 CONSTRUCT INLET PROTECTION AROUND AREA DRAIN CONSISTING OF COMPOST FILTER SOCK AND TEMPORARILY PLUG OUTLET PIPE TO PREVENT TURBID WATER FROM LEAVING THE SITE UNTIL UPSTREAM DISTURBED SOIL IS STABILIZED
- 11 SAW CUT SLURRY CANNOT BE DISCHARGED TO THE CATCH BASIN. USE ALTERNATIVE METHOD SUCH AS WET VACUUM TO COLLECT THE SAW CUT SLURRY.

EROSION CONTROL NOTES


1. MAINTAIN PERIMETER CONTROLS (SEDIMENT BARRIERS, CONSTRUCTION FENCING, CONSTRUCTION ENTRANCES, AND INLET PROTECTION) FOR THE DURATION OF THE PROJECT. PROVIDE INLET PROTECTION AS NEEDED IMMEDIATELY FOLLOWING INSTALLATION OF NEW STORMWATER INLETS/AREA DRAINS. REMOVE CONSTRUCTION ENTRANCE PRIOR TO BASE ROCK PLACEMENT OR PAVING WHERE APPLICABLE.
2. TEMPORARY SLOPE STABILIZATION MEASURES SHALL INCLUDE COVERING EXPOSED SOIL WITH PLASTIC SHEETING, STRAW MULCHING, OR OTHER APPROVED METHODS.
3. LOCATE STOCKPILES AWAY FROM CONSTRUCTION ACTIVITIES THAT CONTAIN SEDIMENT OR SOIL.
4. STOCKPILED TOPSOIL, STRIPPING AND IMPORTED FILL MATERIAL SHALL BE PLACED IN A STABLE CONFIGURATION. DURING WET WEATHER PERIODS, STOCKPILES SHALL BE COVERED WITH PLASTIC SHEETING. SEDIMENT BARRIER IS REQUIRED AROUND THE PERIMETER OF THE STOCKPILE.
5. TEMPORARILY STABILIZE EXPOSED SOILS WITH SEEDING, MULCH, MATS, PLASTIC SHEETING, OR ROCK AS NEEDED. USE BERMS OR SWALES TO DIVERT RUNOFF AS NEEDED. DO NOT PLACE GRAVEL IN THE STREET. COVER TEMPORARY STOCKPILES.

EROSION CONTROL LEGEND


- APPROXIMATE LIMITS OF DISTURBANCE
- SILT FENCE SEDIMENT BARRIER
- ORANGE CONSTRUCTION FENCE
- ▣ CONSTRUCTION ENTRANCE
- (A) LOCATION OF POLLUTANT-GENERATING ACTIVITIES AND AUTHORIZED NON-STORMWATER DISCHARGES (SEE TABLES ON SHEET EC1 FOR DESCRIPTIONS)
- (CW) APPROXIMATE LOCATION CONCRETE WASHOUT

STREET AND UTILITIES PHASE INFORMATION

1. RUNOFF FROM IMPERVIOUS SURFACES (I.E. PAVEMENT, WALKS, ROOFS) WILL BE DIRECTED INTO ON-SITE VEGETATED INFILTRATION FACILITIES FOR STORMWATER DISPOSAL. FACILITIES ARE SIZED PER THE FLORENCE STORMWATER MANUAL TO MEET POLLUTION REDUCTION AND FLOW CONTROL STANDARDS. FINAL STORMWATER DESTINATION IS INFILTRATION INTO GROUNDWATER. FACILITIES ARE SIZED TO TEMPORARILY STORE AND INFILTRATE THE RUNOFF VOLUME GENERATED FOR A 25-YEAR RECURRENCE INTERVAL. TO ACCOMMODATE EXCESS INFLOW, THE STORMWATER FACILITIES WILL INCLUDE OVERFLOW STANDPIPES THAT DISCHARGE INTO A PUBLIC STORMWATER PIPE SYSTEM IN 37TH STREET. THE FACILITIES WILL BE VEGETATED PER THE PROJECT LANDSCAPE PLANS.
2. TEMPORARILY CAP OR PLUG THE OVERFLOW STANDPIPES TO PREVENT TURBID WATER FROM LEAVING THE SITE UNTIL THE INFILTRATION FACILITY HAS BEEN STABILIZED WITH VEGETATION, PEA GRAVEL MULCH, OR SIMILAR COVERING.
3. RUNOFF FROM RIGHT-OF-WAY IMPERVIOUS SURFACES (STREET AND WALKS) DRAIN INTO STREET-SIDE VEGETATED SWALES/PLANTER. RUNOFF FROM ROOF AND PAVED ACCESS/PARKING AREAS DRAIN INTO ON-SITE VEGETATED RAIN GARDENS/PLANTER.

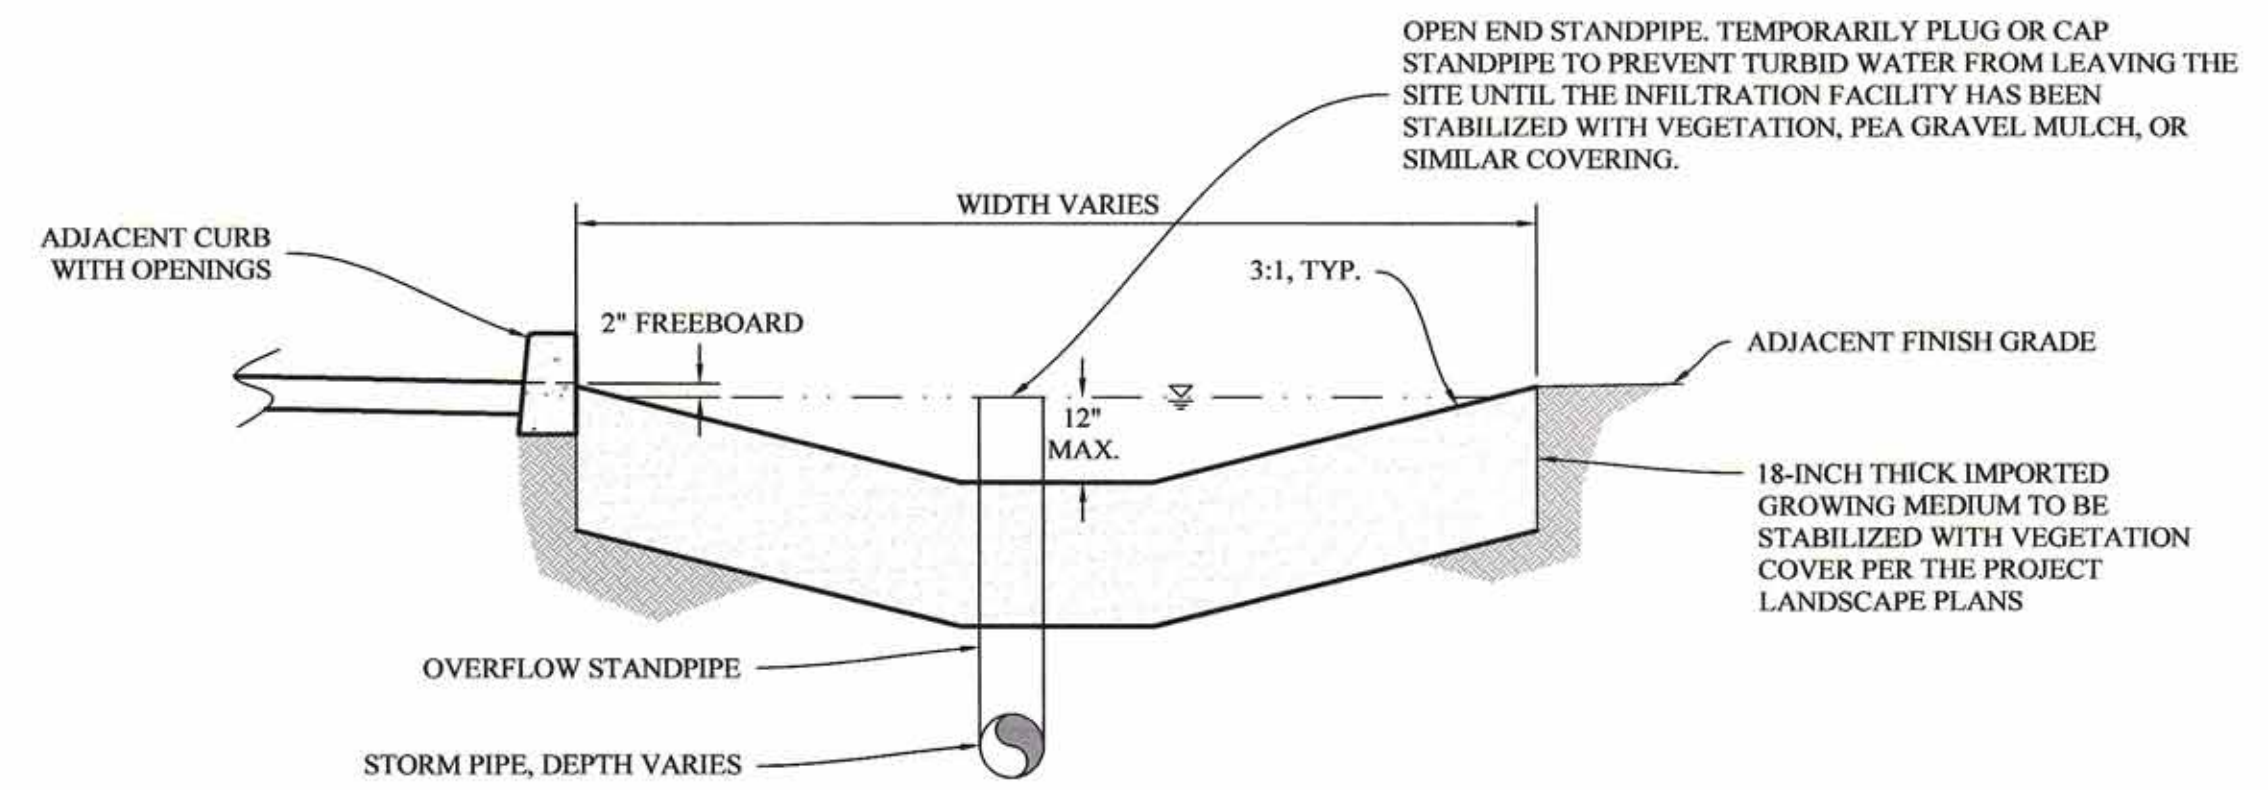

TYPICAL INFILTRATION FACILITY OVERFLOW STANDPIPE
N.T.S.

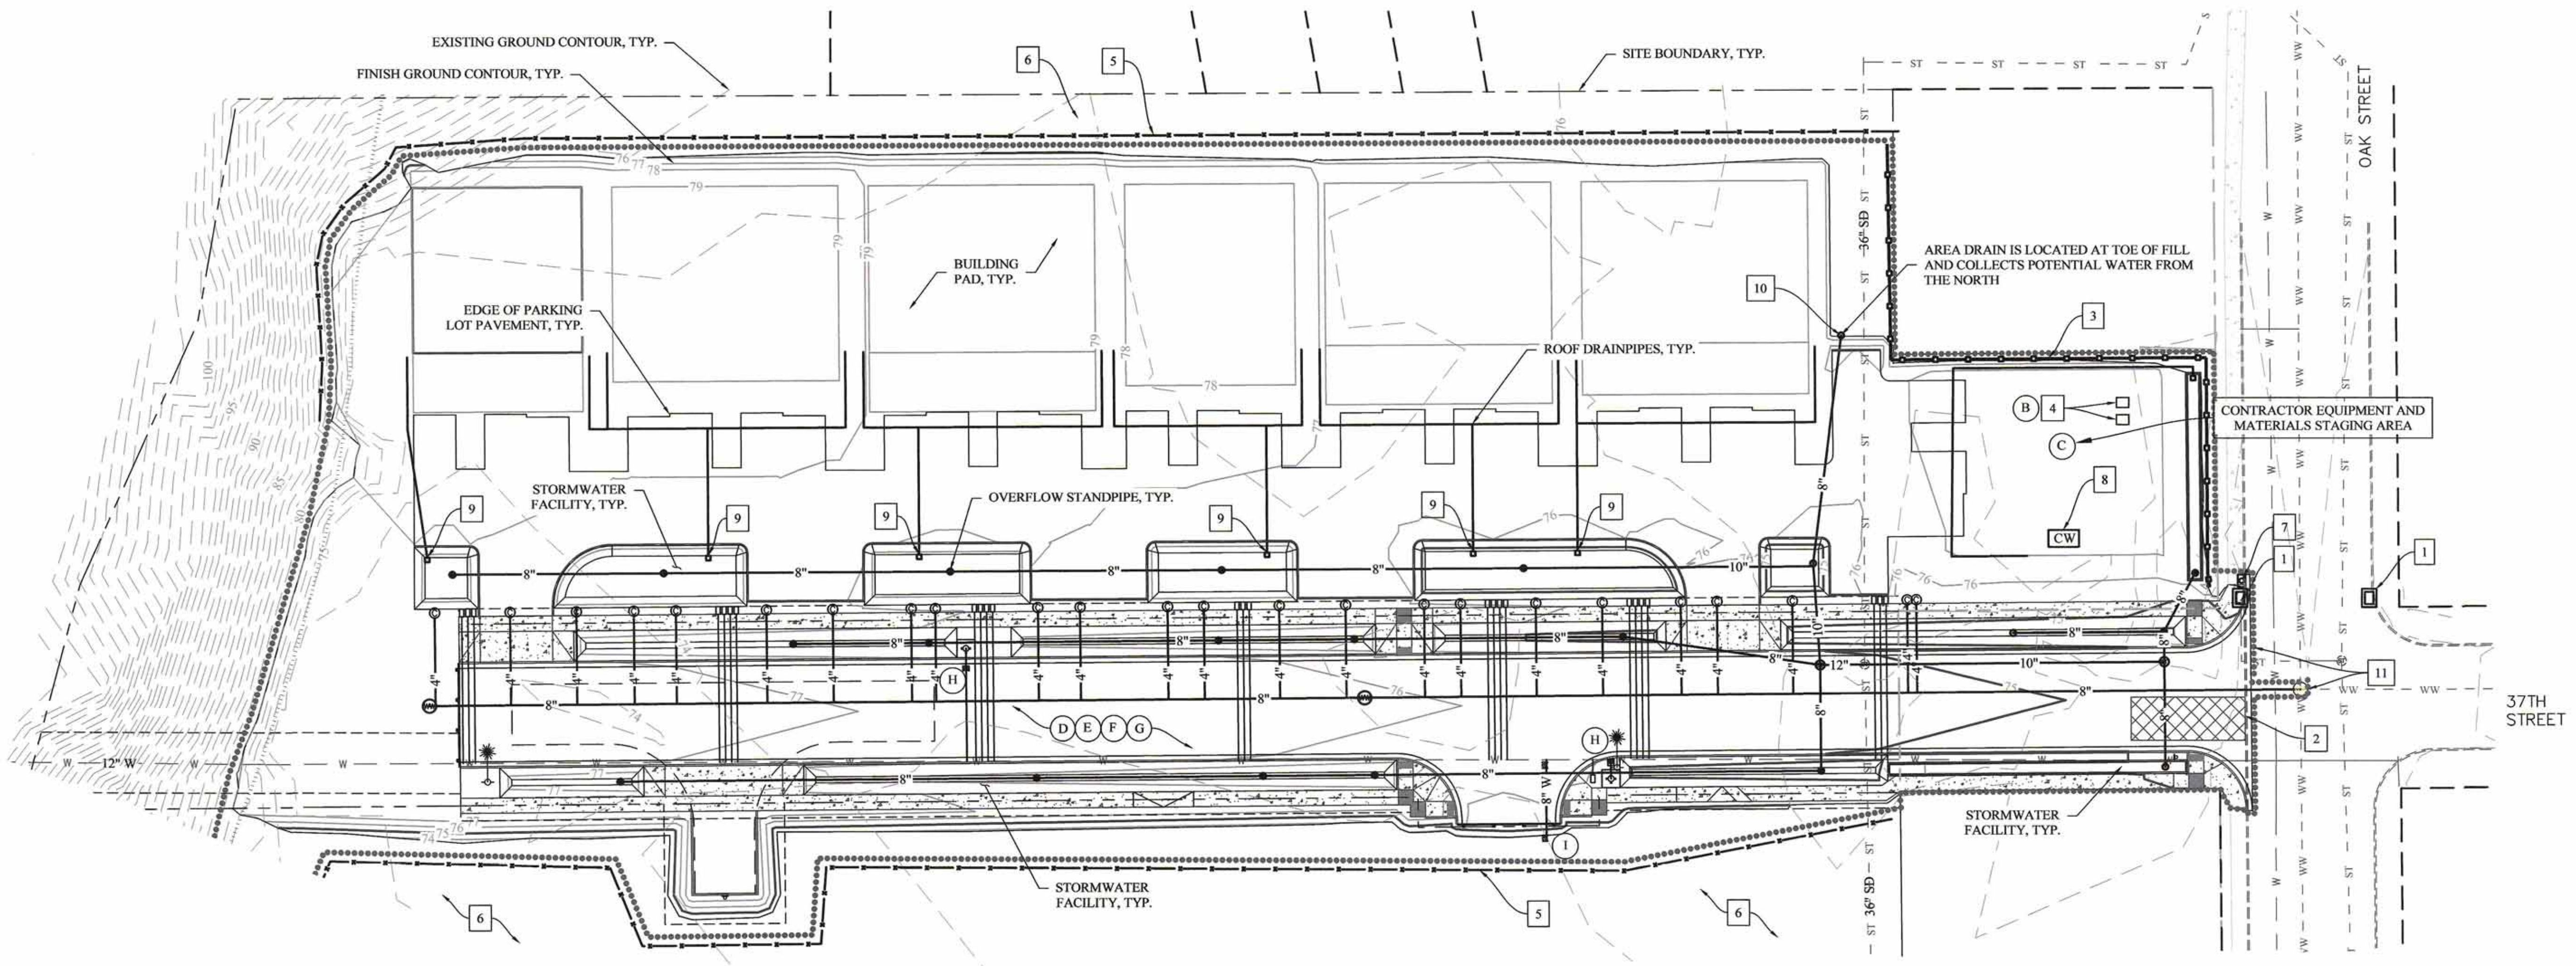

STREET AND UTILITIES PLAN

1" = 30'

EGR & Associates, Inc.
Engineers and Surveyors
2535B Prairie Road
Eugene, Oregon 97402
(541) 688-8332
Fax (541) 688-8087

REGISTERED PROFESSIONAL ENGINEER
STATE OF OREGON
No. 13376
Exp. 03/31/2025
CLINTON L. BEECROFT
RENEWALS: 01/01/24

MYRTLE GLEN PUD
FINAL PUD IMPROVEMENT DRAWINGS
EROSION AND SEDIMENT CONTROL
STREET AND UTILITIES
FLORENCE, OREGON

| No | Description of Revisions | Date | Name |
|----|--------------------------|------|------|
| | | | |
| | | | |
| | | | |

| | |
|------------|--------------|
| Date | 09-25-2023 |
| Job Number | 7091-22-0187 |
| Design by | C. BEECROFT |
| Drawn by | C. BEECROFT |
| Checked by | C. BEECROFT |

Sheet Number

EC5

Plot Date: 09-25-2023 11:07am
S:\Projects\7091-22-0187-37th Street\Phase 1\PEP\Sheet\22-0187-Erosion Control.dwg LAYOUT-EC5
FILE INFO Name File

CONSTRUCTION NOTES

- 1 MAINTAIN INLET PROTECTION THROUGHOUT CONSTRUCTION DURATION, UNLESS INLET IS REMOVED
- 2 TOWNHOUSE BUILDING ON CONCRETE FOUNDATION
- 3 MAINTAIN SILT FENCE SEDIMENT BARRIER THROUGHOUT CONSTRUCTION DURATION
- 4 PORTABLE SANITARY FACILITY AND TRASH BIN WITH LID
- 5 MAINTAIN ORANGE CONSTRUCTION FENCE TO PROTECT EXISTING VEGETATION
- 6 PRESERVE EXISTING VEGETATION OUTSIDE WORK ZONES
- 7 CONCRETE WALKWAY, TYPICAL AT ALL TOWNHOUSE UNITS
- 8 CONSTRUCT CONCRETE WASHOUT PER STD DWG RD1070 (LOCATION TO BE DETERMINED BY INSTALLING CONTRACTOR)
- 9 MAINTAIN INLET PROTECTION AROUND AREA DRAIN AND TEMPORARILY PLUG OUTLET PIPE TO PREVENT TURBID WATER FROM LEAVING THE SITE UNTIL UPSTREAM DISTURBED SOIL IS STABILIZED
- 10 CONSTRUCT CONSTRUCTION ENTRANCE - TYPE 1 PER OREGON STD DWG RD1000, UNTIL PARKING LOT AREA IS ROCKED OR PAVED
- 11 CONTAINER FOR STORING CONSTRUCTION MATERIALS AND FOR SPILL KITS AND SPILL CONTAINMENT DEVICES (APPROXIMATE LOCATION)

EROSION CONTROL NOTES


1. MAINTAIN PERIMETER CONTROLS (SEDIMENT BARRIERS, CONSTRUCTION FENCING, CONSTRUCTION ENTRANCES, AND INLET PROTECTION) FOR THE DURATION OF THE PROJECT. PROVIDE INLET PROTECTION AS NEEDED IMMEDIATELY FOLLOWING INSTALLATION OF NEW STORMWATER INLETS/AREA DRAINS. REMOVE CONSTRUCTION ENTRANCE PRIOR TO BASE ROCK PLACEMENT OR PAVING WHERE APPLICABLE.
2. TEMPORARY SLOPE STABILIZATION MEASURES SHALL INCLUDE COVERING EXPOSED SOIL WITH PLASTIC SHEETING, STRAW MULCHING, OR OTHER APPROVED METHODS.
3. LOCATE STOCKPILES AWAY FROM CONSTRUCTION ACTIVITIES THAT CONTAIN SEDIMENT OR SOIL.
4. STOCKPILED TOPSOIL STRIPPING AND IMPORTED FILL MATERIAL SHALL BE PLACED IN A STABLE CONFIGURATION. DURING WET WEATHER PERIODS, STOCKPILES SHALL BE COVERED WITH PLASTIC SHEETING. SEDIMENT BARRIER IS REQUIRED AROUND THE PERIMETER OF THE STOCKPILE.
5. TEMPORARILY STABILIZE EXPOSED SOILS WITH SEEDING, MULCH, MATS, PLASTIC SHEETING, OR ROCK AS NEEDED. USE BERMS OR SWALES TO DIVERT RUNOFF AS NEEDED. DO NOT PLACE GRAVEL IN THE STREET. COVER TEMPORARY STOCKPILES.

EROSION CONTROL LEGEND

- APPROXIMATE LIMITS OF DISTURBANCE
- SILT FENCE SEDIMENT BARRIER
- +— ORANGE CONSTRUCTION FENCE
- ▣ CONSTRUCTION ENTRANCE
- (A) LOCATION OF POLLUTANT-GENERATING ACTIVITIES AND AUTHORIZED NON-STORMWATER DISCHARGES (SEE TABLES ON SHEET EC1 FOR DESCRIPTIONS)
- (CW) APPROXIMATE LOCATION CONCRETE WASHOUT

VERTICAL CONSTRUCTION PHASE INFORMATION

1. BUILDING CONSTRUCTION WILL GENERALLY PROGRESS FROM EAST TO WEST. PARKING LOT AREA PAVING MAY BE PERFORMED IN STAGES AS TOWNHOUSE UNITS ARE FINISHED OR ALL AT ONCE. MAINTAIN CONSTRUCTION ENTRANCES AS NEEDED UNTIL THE ENTIRE PARKING AREA IS ROCKED OR PAVED TO PREVENT TRACKING ONTO 37TH STREET.
2. PROVIDE ENCLOSED STORAGE CONTAINER FOR SPILL KITS AND SPILL CONTAINMENT DEVICES (WATTLES, FILTER SOCKS, ABSORBENT BOOMS, ETC.) THROUGH COMPLETION OF VERTICAL CONSTRUCTION. POTENTIAL POLLUTANT GENERATING CONSTRUCTION MATERIALS (I.E. PAINTS, CAULKS, SEALANTS, SOLVENTS, ETC.) SHALL BE STORED IN THE CONTAINER WHEN NOT IN USE.

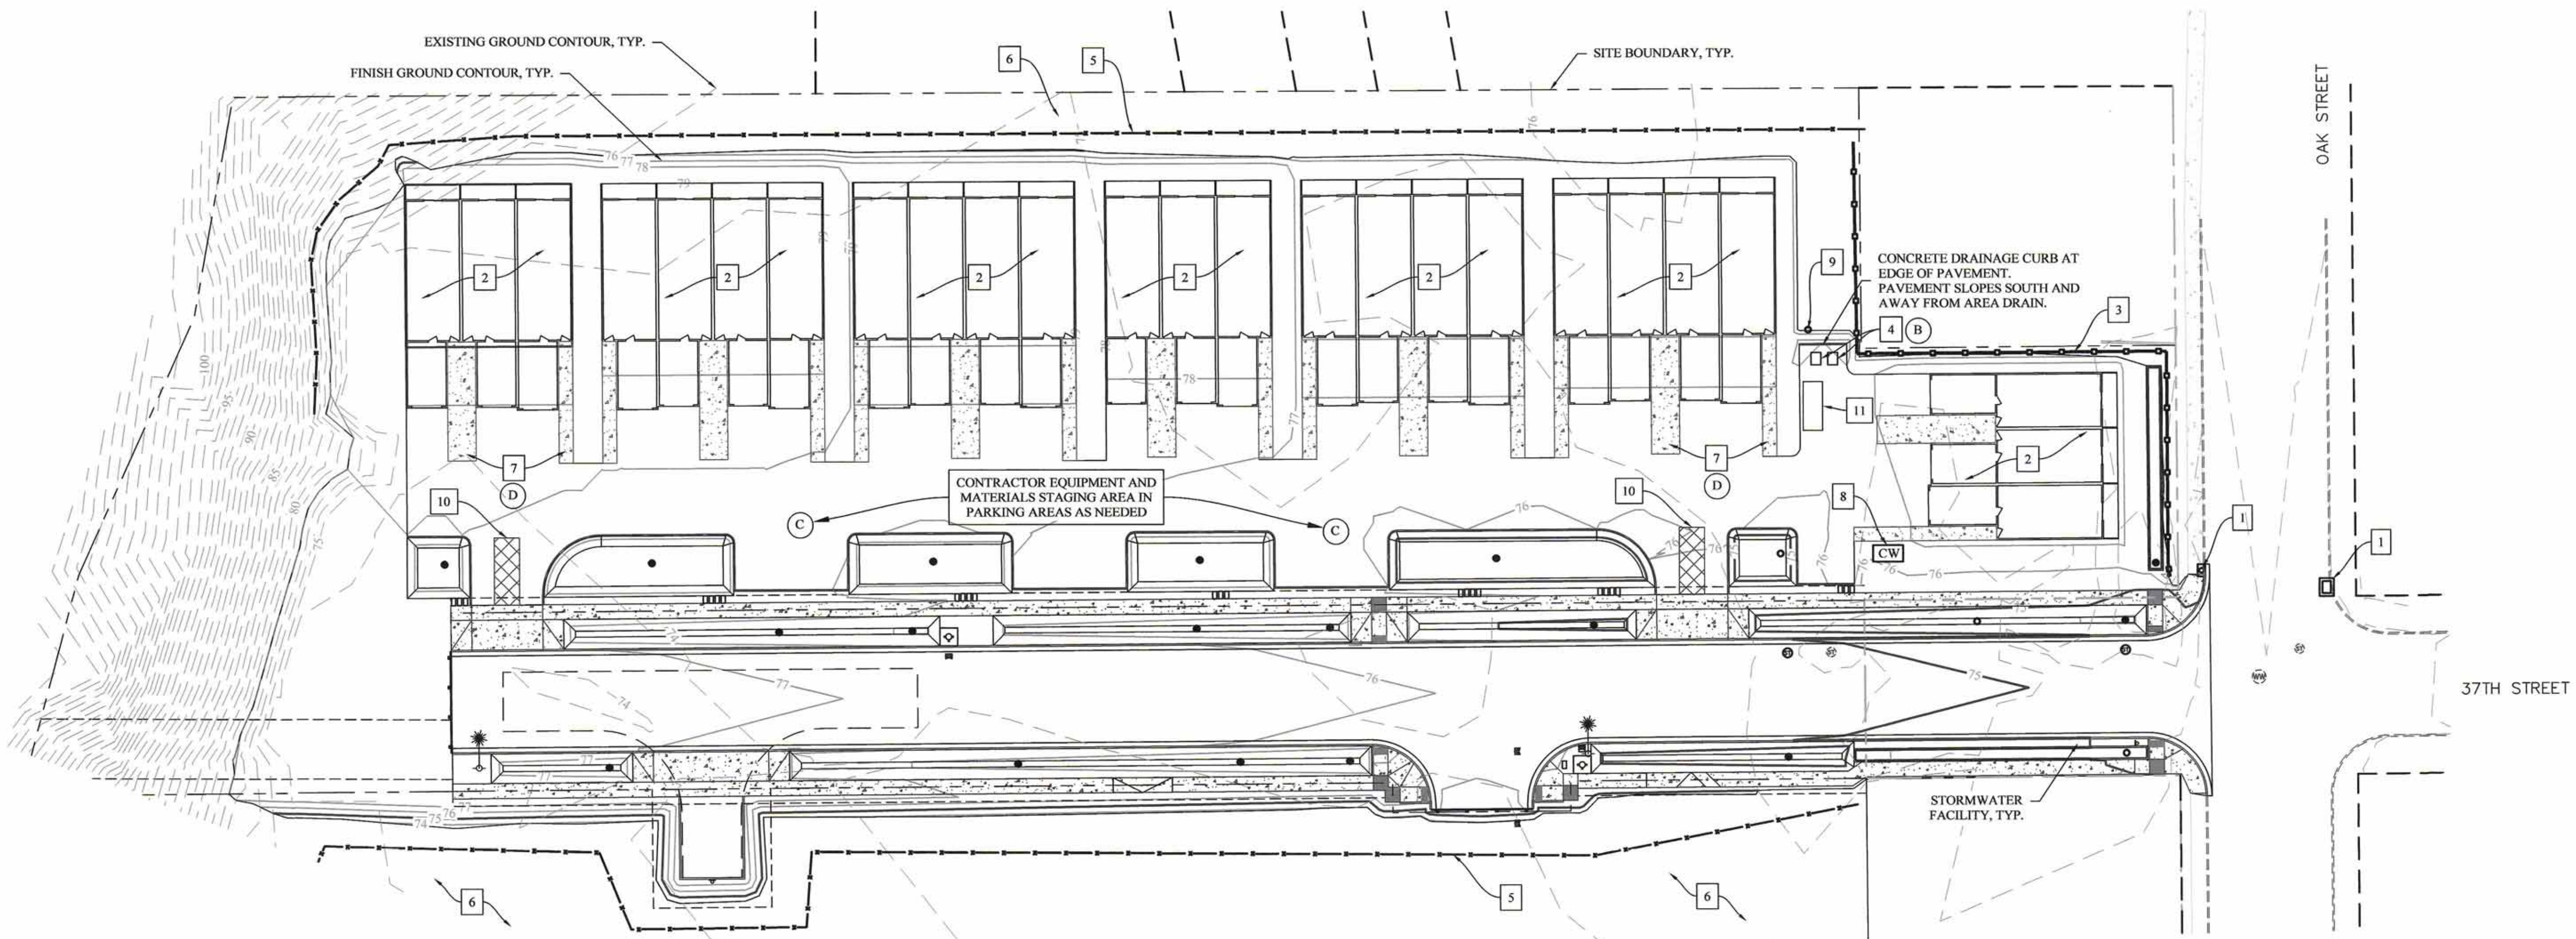

VERTICAL CONSTRUCTION PLAN

1" = 30'

CONTOUR INTERVAL IS 5-FOOT
CONTOUR LINES DERIVED FROM LIDAR
ELEVATION DATUM NAVD88

ECR & Associates, Inc.
Engineers and Surveyors
2535B Prairie Road
Eugene, Oregon 97402
(541) 888-8322
Fax (541) 888-8087

REGISTERED PROFESSIONAL ENGINEER
STATE OF OREGON
NO. 15370
CLINTON L. BEECROFT
RENEWALS: 01/01/24

MYRTLE GLEN PUD
FINAL PUD IMPROVEMENT DRAWINGS
EROSION AND SEDIMENT CONTROL
VERTICAL CONSTRUCTION
FLORENCE, OREGON

| No | Description of Revisions | Date | Name |
|----|--------------------------|------|------|
| | | | |
| | | | |
| | | | |

| | |
|------------|--------------|
| Date | 09-25-2023 |
| Job Number | 7091-22-0187 |
| Design by | C. BEECROFT |
| Drawn by | C. BEECROFT |
| Checked by | C. BEECROFT |

Sheet Number
EC6

CONSTRUCTION NOTES

- 1 PLACE SEEDED COMPOST WITH PERMANENT SEEDING ON ALL DISTURBED SOIL LOCATED OUTSIDE OF LANDSCAPED AREAS
- 2 PLANT ALL STORMWATER FACILITIES AND AREAS SURROUNDING THE BUILDINGS PER THE PROJECT LANDSCAPE PLANS
- 3 STREET CUT FOR UTILITY INSTALLATIONS TO BE RESURFACED ASPHALT PAVEMENT, TYPICAL

EROSION CONTROL NOTES

- 1. LONG TERM SLOPE STABILIZATION MEASURES OVER DISTURBED SURFACES SHALL INCLUDE PLACEMENT OF 8" TO 12" THICK GROUND SEEDED "ROOT-MAT" OR OTHER LOCALLY AVAILABLE SEEDED MULCH, PERMANENT SEEDING AS NEEDED, AND VEGETATION ESTABLISHMENT.
- 2. SEEDING METHODS SHALL BE AS DESCRIBED IN SECTION 01030.48 OF THE ODOT STANDARD SPECIFICATIONS. METHOD A CONSISTS OF HYDROSEEDING, FERTILIZING, HYDROMULCHING, AND TACKING IN ONE OPERATION. METHOD B CONSISTS OF SEEDING, FERTILIZING, DRY MULCHING, AND TRACKING IN SEPARATE STEPS.
- 3. PLANT STORMWATER RAIN GARDENS, PLANTERS AND STREET-SIDE SWALES IN CONFORMANCE WITH PROJECT LANDSCAPE PLANS.
- 4. MAINTAIN PERIMETER SEDIMENT CONTROLS AND INLET PROTECTION UNTIL SITE IS STABILIZED.



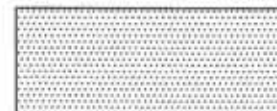
EROSION CONTROL LEGEND


..... APPROXIMATE LIMITS OF DISTURBANCE

FINAL SITE STABILIZATION PHASE INFORMATION

- 1. FINAL SITE STABILIZATION WILL CONSIST OF IMPERVIOUS SURFACES (ROOF AND PAVEMENT) AND FINAL SEEDING/LANDSCAPING OF ALL DISTURBED SOIL.
- 2. PROJECT LANDSCAPE PLANS HAVE BEEN DEVELOPED FOR LANDSCAPED AREAS SURROUNDING THE BUILDINGS AND FOR ALL VEGETATED STORMWATER FACILITIES (SWALES, PLANTERS, AND RAIN GARDENS). ALL DISTURBED SOIL THAT IS OUTSIDE OF LANDSCAPED AREAS WILL BE STABILIZED WITH MULCH AND PERMANENT SEEDING PER THE SEED SPECIFICATIONS.

FINAL STABILIZATION LEGEND

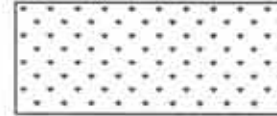
-  FINAL VEGETATION OF LANDSCAPED AND SEEDED SURFACES
SURFACE AREA = 2.58 ACRE
-  IMPERVIOUS SURFACES - BUILDING ROOFS
SURFACE AREA = 0.84 ACRE
-  IMPERVIOUS SURFACES - CONCRETE AND ASPHALT PAVEMENT
SURFACE AREA = 1.30 ACRES

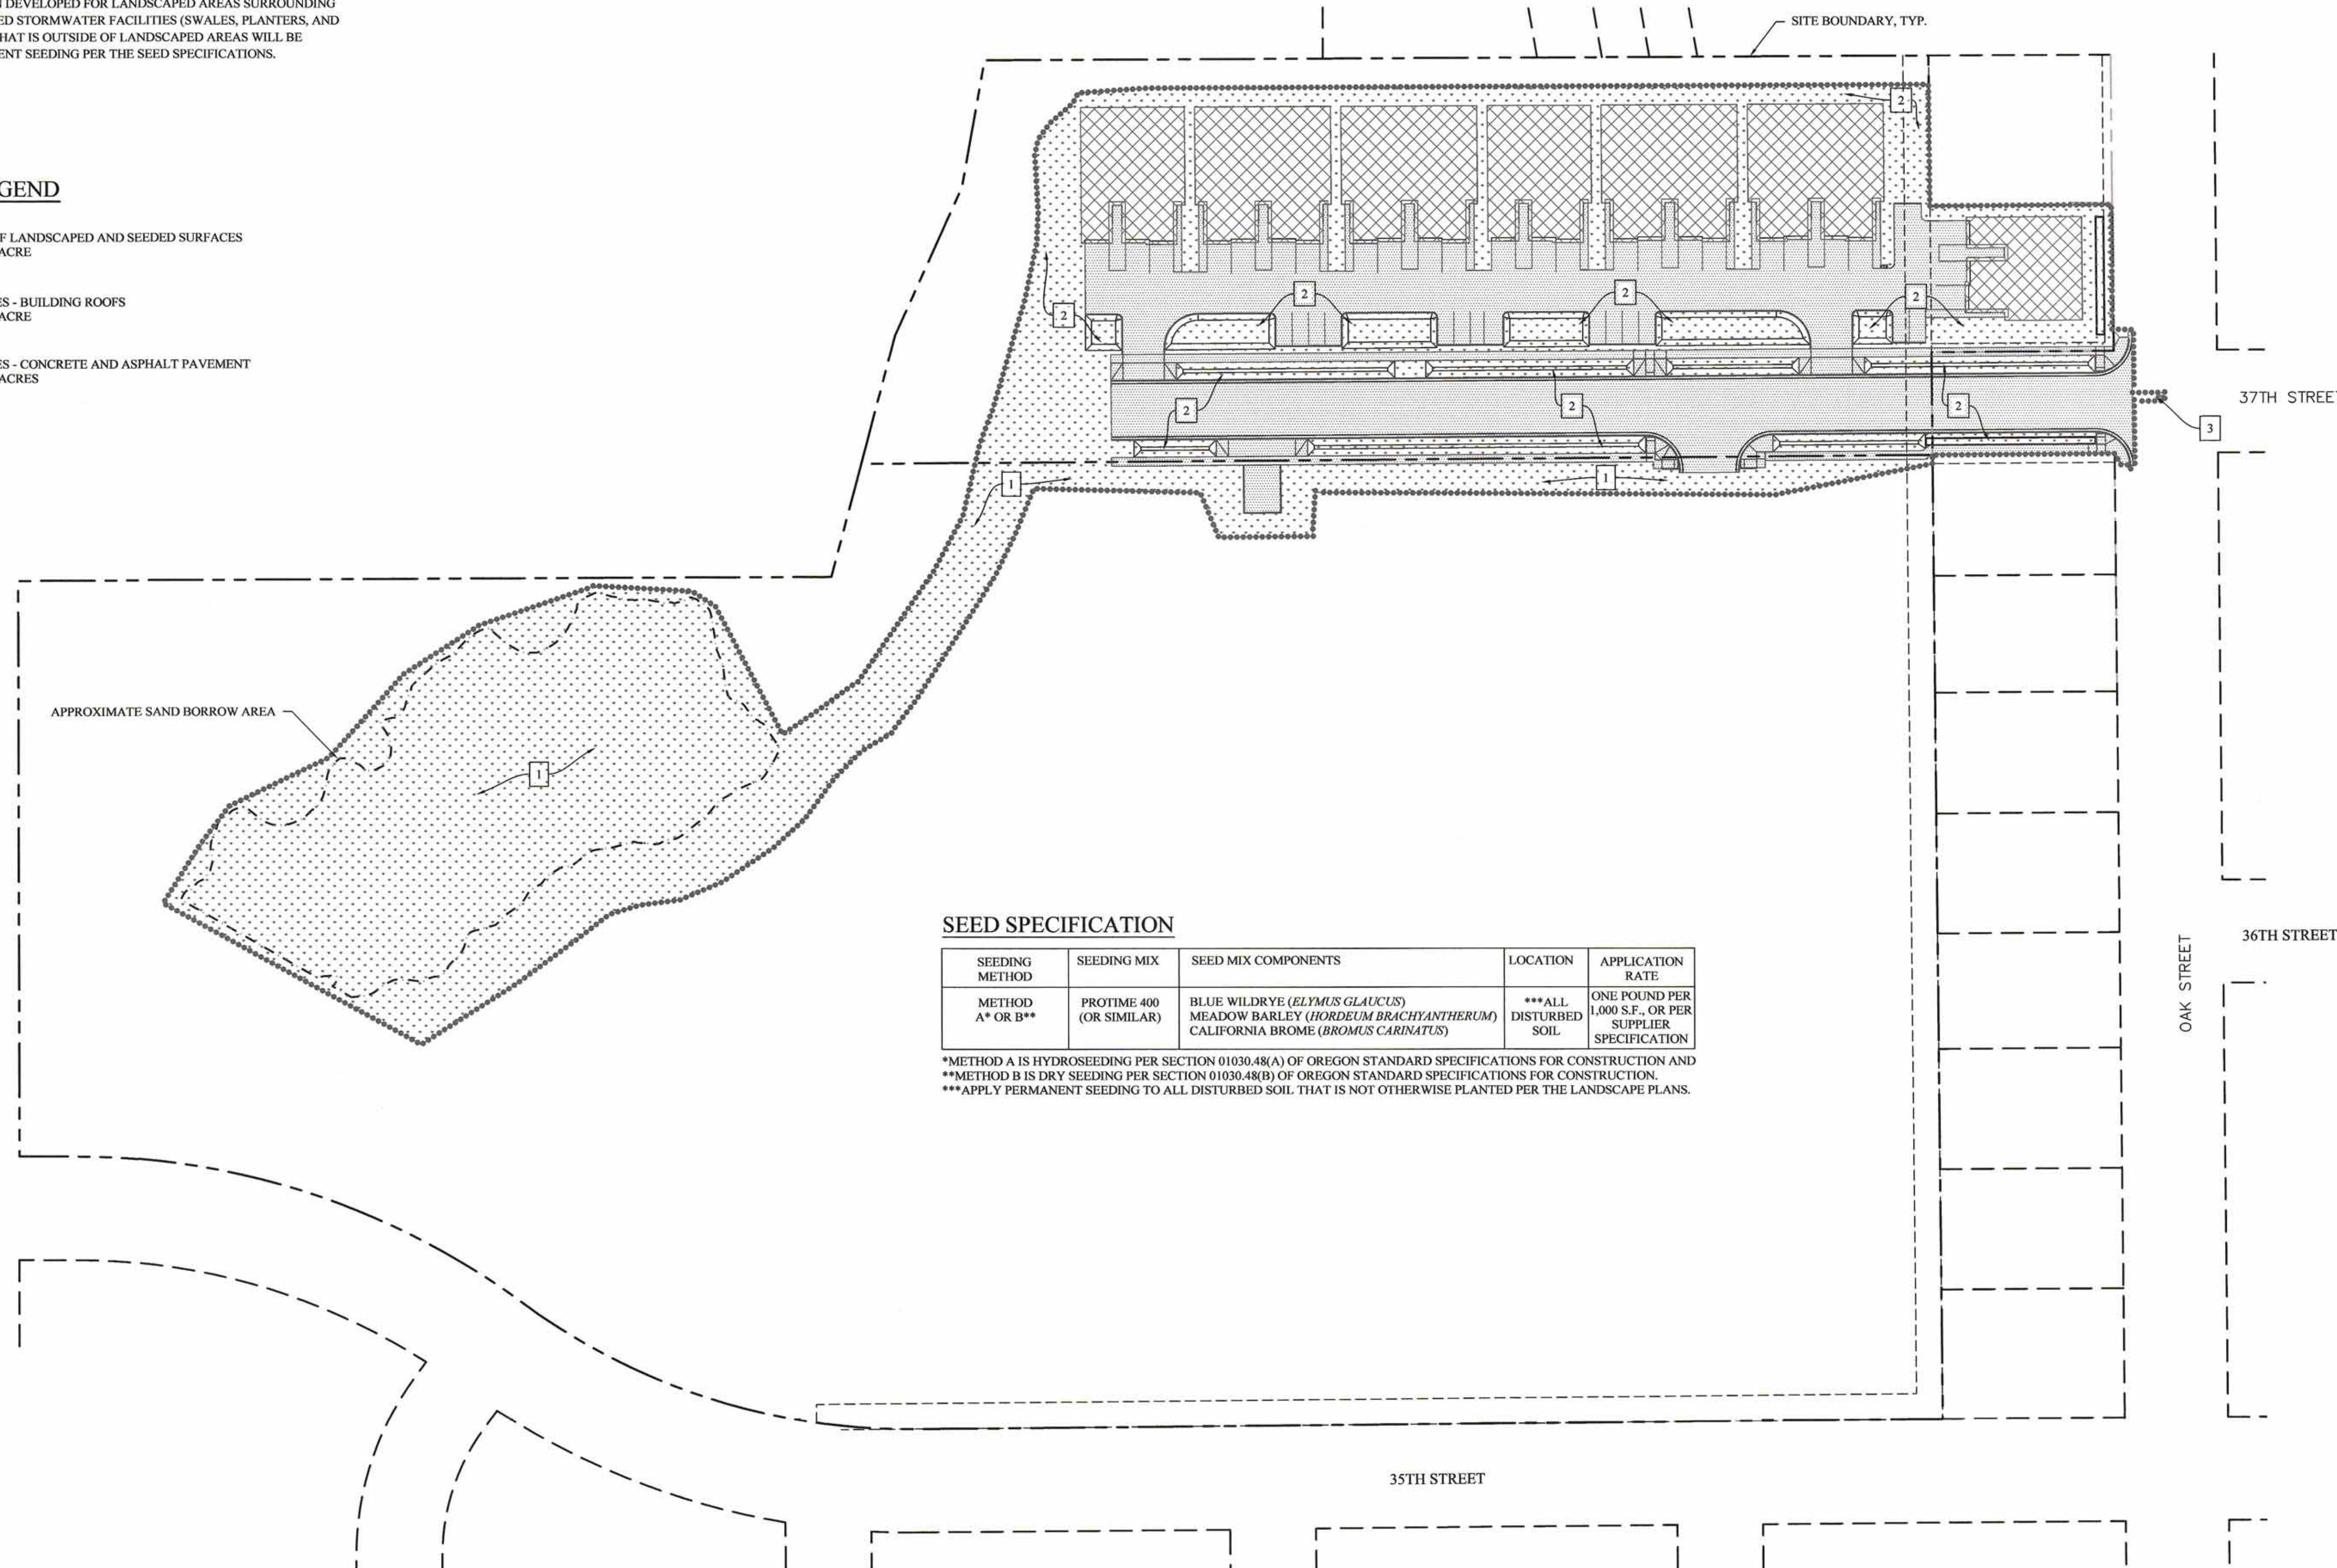

SEED SPECIFICATION

| SEEDING METHOD | SEEDING MIX | SEED MIX COMPONENTS | LOCATION | APPLICATION RATE |
|------------------|--------------------------|---|-----------------------|---|
| METHOD A* OR B** | PROTIME 400 (OR SIMILAR) | BLUE WILDRYE (<i>ELYMUS GLAUCUS</i>) MEADOW BARLEY (<i>HORDEUM BRACHYANTHERUM</i>) CALIFORNIA BROME (<i>BROMUS CARINATUS</i>) | ***ALL DISTURBED SOIL | ONE POUND PER 1,000 S.F., OR PER SUPPLIER SPECIFICATION |

*METHOD A IS HYDROSEEDING PER SECTION 01030.48(A) OF OREGON STANDARD SPECIFICATIONS FOR CONSTRUCTION AND
 **METHOD B IS DRY SEEDING PER SECTION 01030.48(B) OF OREGON STANDARD SPECIFICATIONS FOR CONSTRUCTION.
 ***APPLY PERMANENT SEEDING TO ALL DISTURBED SOIL THAT IS NOT OTHERWISE PLANTED PER THE LANDSCAPE PLANS.

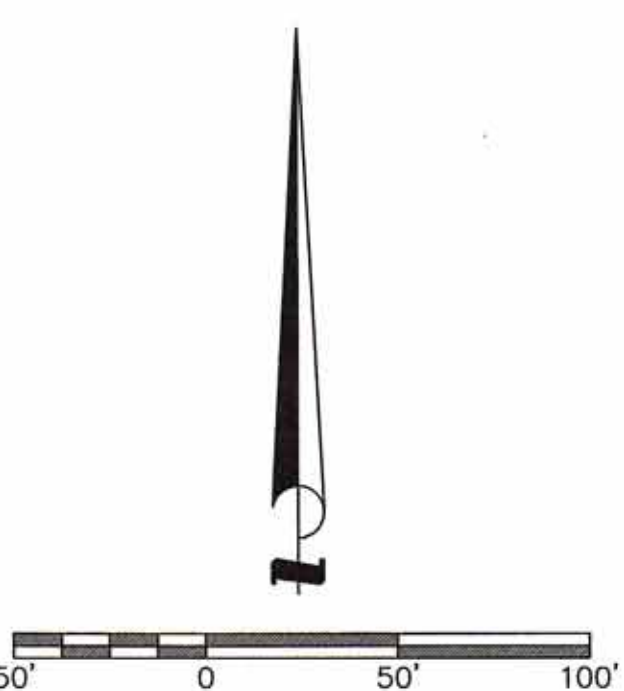

FINAL SITE STABILIZATION PLAN

1" = 50'


EGR & Associates, Inc.
 Engineers and Surveyors
 2535B Prairie Road
 Eugene, Oregon 97402
 (541) 888-8322
 Fax (541) 888-8087

REGISTERED PROFESSIONAL ENGINEER
 STATE OF OREGON
 No. 15378
 CLINTON L. BEECROFT
 9-25-2023
 RENEWS: 01/01/24

MYRTLE GLEN PUD
 FINAL PUD IMPROVEMENT DRAWINGS
 EROSION AND SEDIMENT CONTROL
 FINAL SITE STABILIZATION
 FLORENCE, OREGON

| No | Description of Revisions | Date | Name |
|----|--------------------------|------|------|
| | | | |
| | | | |
| | | | |
| | | | |
| | | | |

| | |
|--------------|--------------|
| Date | 09-25-2023 |
| Job Number | 7091-22-0187 |
| Design by | C. BEECROFT |
| Drawn by | C. BEECROFT |
| Checked by | C. BEECROFT |
| Sheet Number | EC7 |

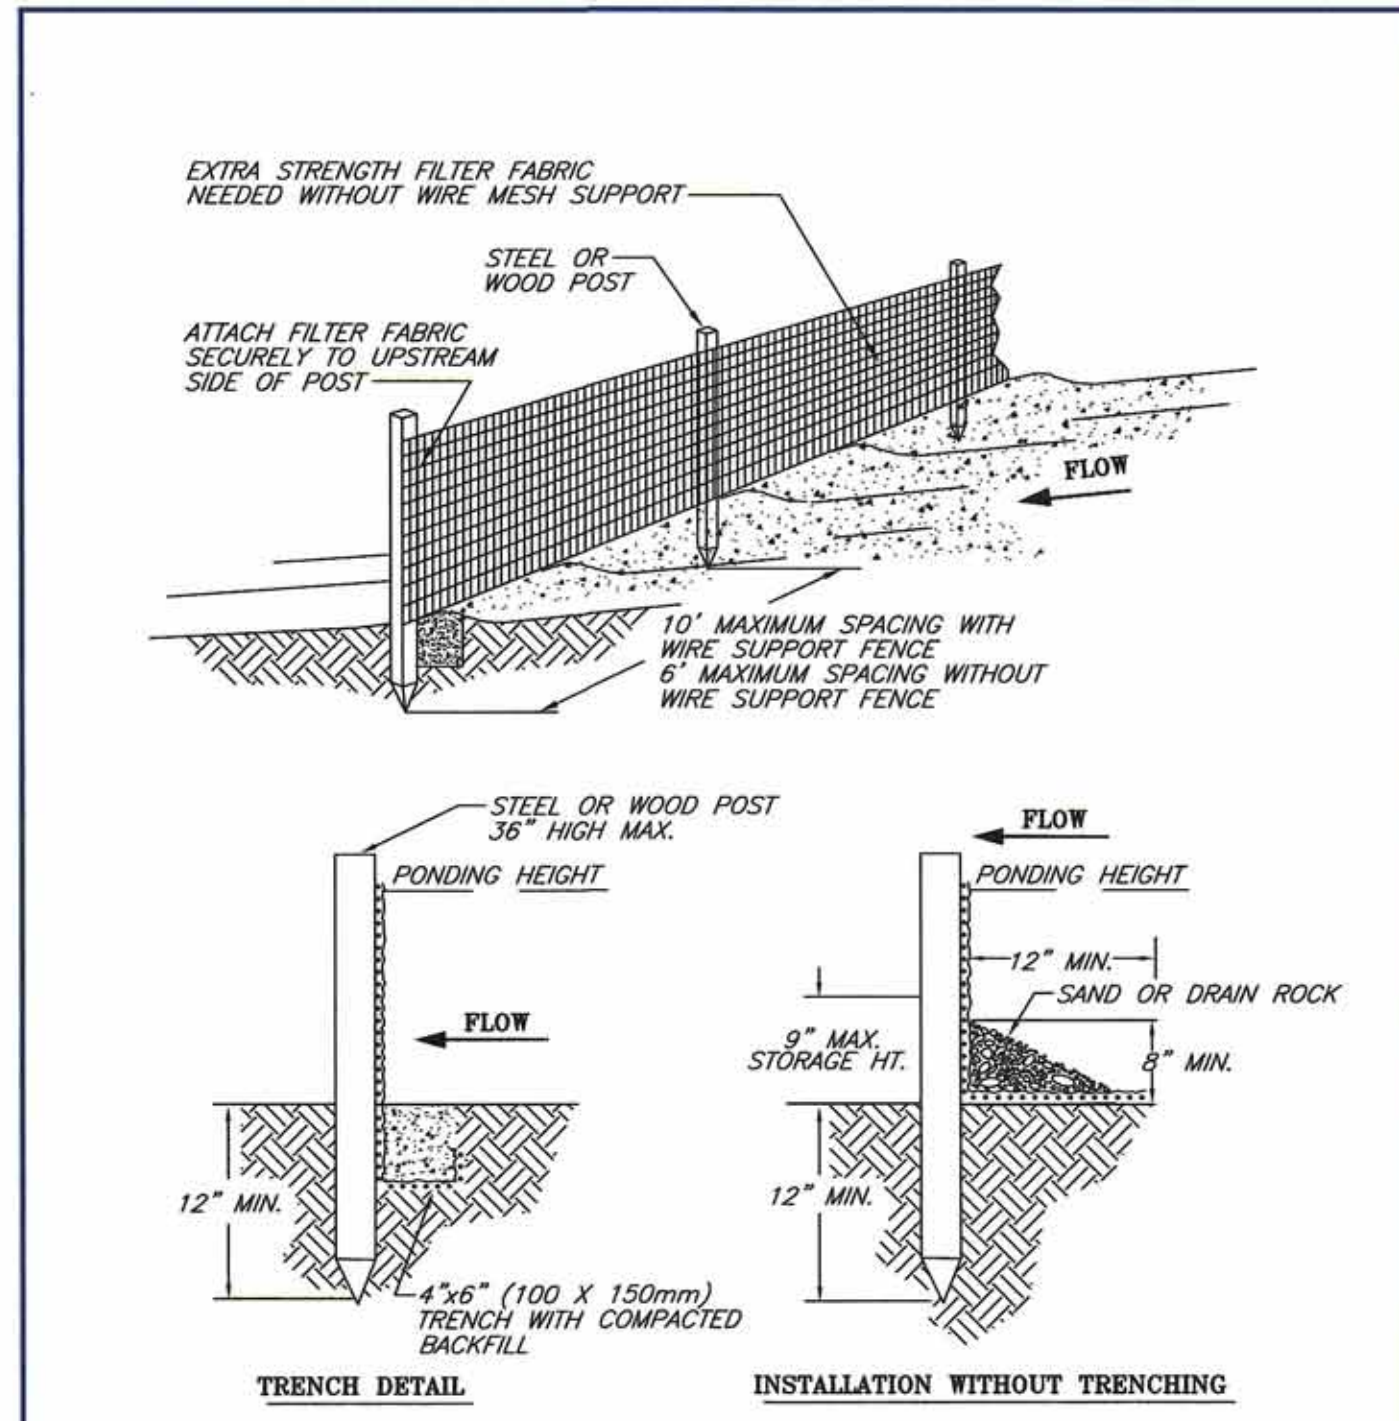


- NOTES:**
- SILT FENCE SHALL BE PLACED ON SLOPE CONTOURS TO MAXIMIZE PONDING EFFICIENCY.
 - INSPECT AND REPAIR FENCE AFTER EACH STORM EVENT AND REMOVE SEDIMENT WHEN NECESSARY. 9" (225mm) MAXIMUM RECOMMENDED STORAGE HEIGHT.
 - REMOVED SEDIMENT SHALL BE DEPOSITED TO AN AREA THAT WILL NOT CONTRIBUTE SEDIMENT OFF-SITE AND CAN BE PERMANENTLY STABILIZED.
 - FENCE TO REMAIN IN PLACE AND MAINTAINED BY CONTRACTOR UNTIL ALL DISTURBED SOILS HAVE BEEN STABILIZED.


CITY OF FLORENCE STANDARD DRAWING

SILT FENCE

DATE: DEC-2011 DRAWING NO: F-101

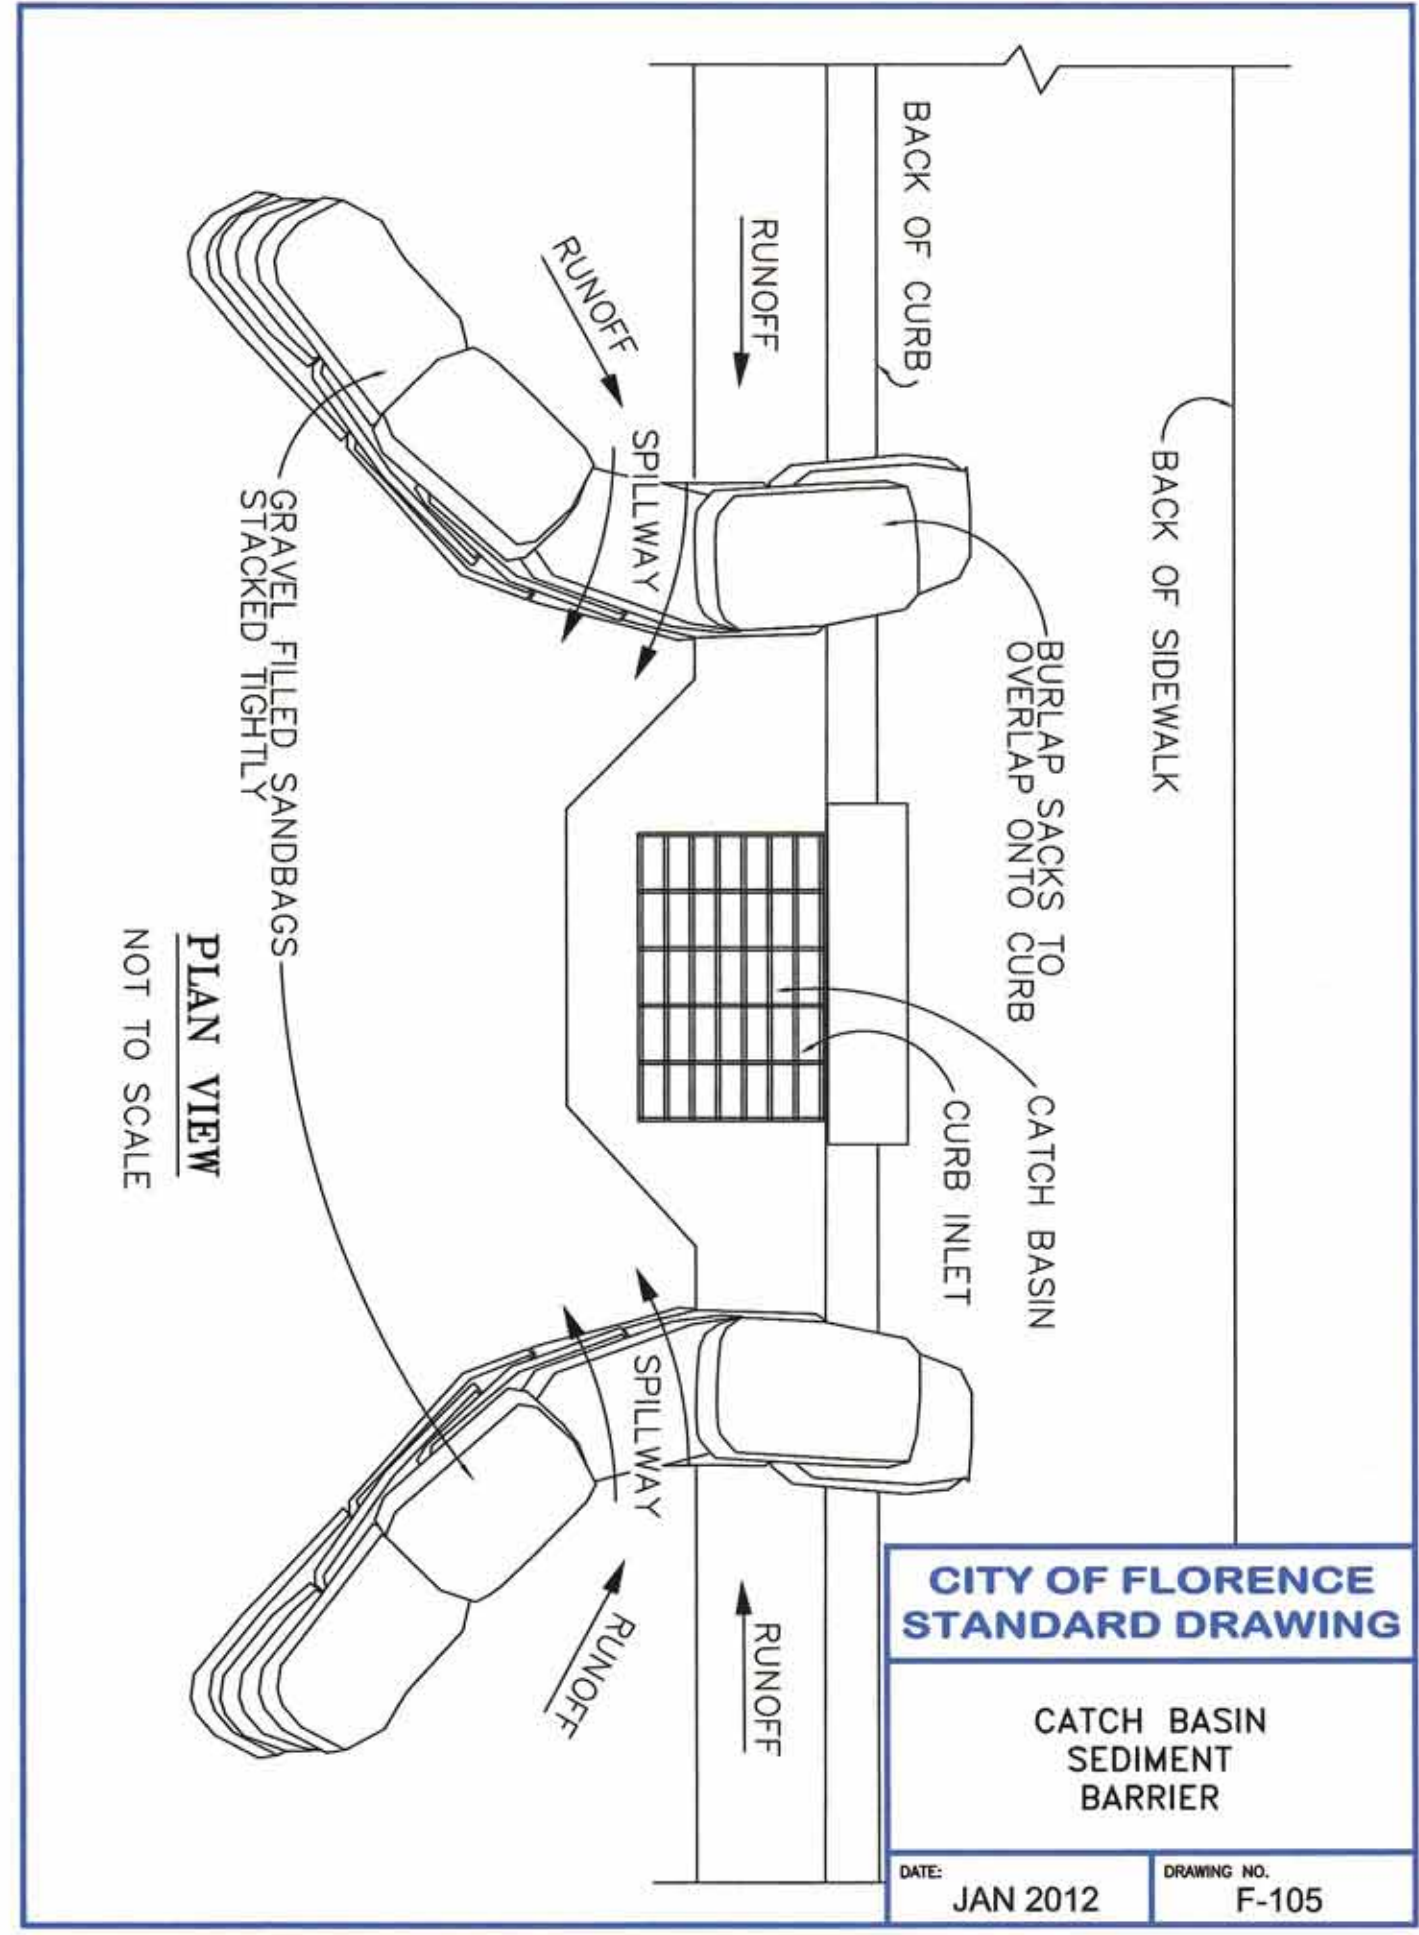

- WASH OUT FACILITY MAINTENANCE**
- DURING PERIODS OF CONCRETE WORK, INSPECT DAILY TO VERIFY CONTINUED PERFORMANCE AND REMAINING CAPACITY (% FULL).
 - MAINTAIN WASH OUT FACILITY TO PROVIDE ADEQUATE HOLDING CAPACITY WITH A MINIMUM FREEBOARD OF 6-INCHES.
 - WASH OUT FACILITY MUST BE CLEANED, OR A NEW FACILITY MUST BE CONSTRUCTED AND READY FOR USE ONCE THE WASHOUT IS 75-PERCENT FULL. HARDENED CONCRETE SHALL BE REMOVED AS NEEDED AND PROPERLY DISPOSED OF.
 - WHEN CONCRETE WASH OUT FACILITIES ARE NO LONGER REQUIRED, THE HARDENED CONCRETE AND MATERIALS USED TO CONSTRUCT CONCRETE WASH OUT FACILITIES SHALL BE REMOVED FROM THE SITE AND PROPERLY DISPOSED OF.
- ROUTINE BMP MAINTENANCE SPECIFICATIONS**
- INLET PROTECTION:** INSPECT INLETS FOLLOWING EACH STORM EVENT AND DAILY WHEN RUNOFF IS OCCURRING. REMOVE ACCUMULATED SEDIMENT AND DEBRIS. MAKE ANY NEEDED REPAIRS IMMEDIATELY.
 - SEDIMENT FENCE:** REMOVE ACCUMULATED SEDIMENT FREQUENTLY AND REPLACE FABRIC AT LEAST EVERY SIX MONTHS WHEN EXPOSED TO FINE CLAY SEDIMENT RUNOFF. DO NOT ALLOW SEDIMENT TO ACCUMULATE BEHIND THE SEDIMENT FENCE ANY HIGHER THAN ONE-THIRD THE ABOVE-GROUND HEIGHT.
 - GRAVEL CONSTRUCTION ENTRANCE:** ANY MATERIAL THAT REACHES THE ROAD MUST BE CLEANED UP IMMEDIATELY BY VACUUM SWEEPING AND NOT WASHED OFF WITH WATER. ADDITIONAL ROCK MAY BE NEEDED PERIODICALLY TO MAINTAIN A CLEAN SURFACE.

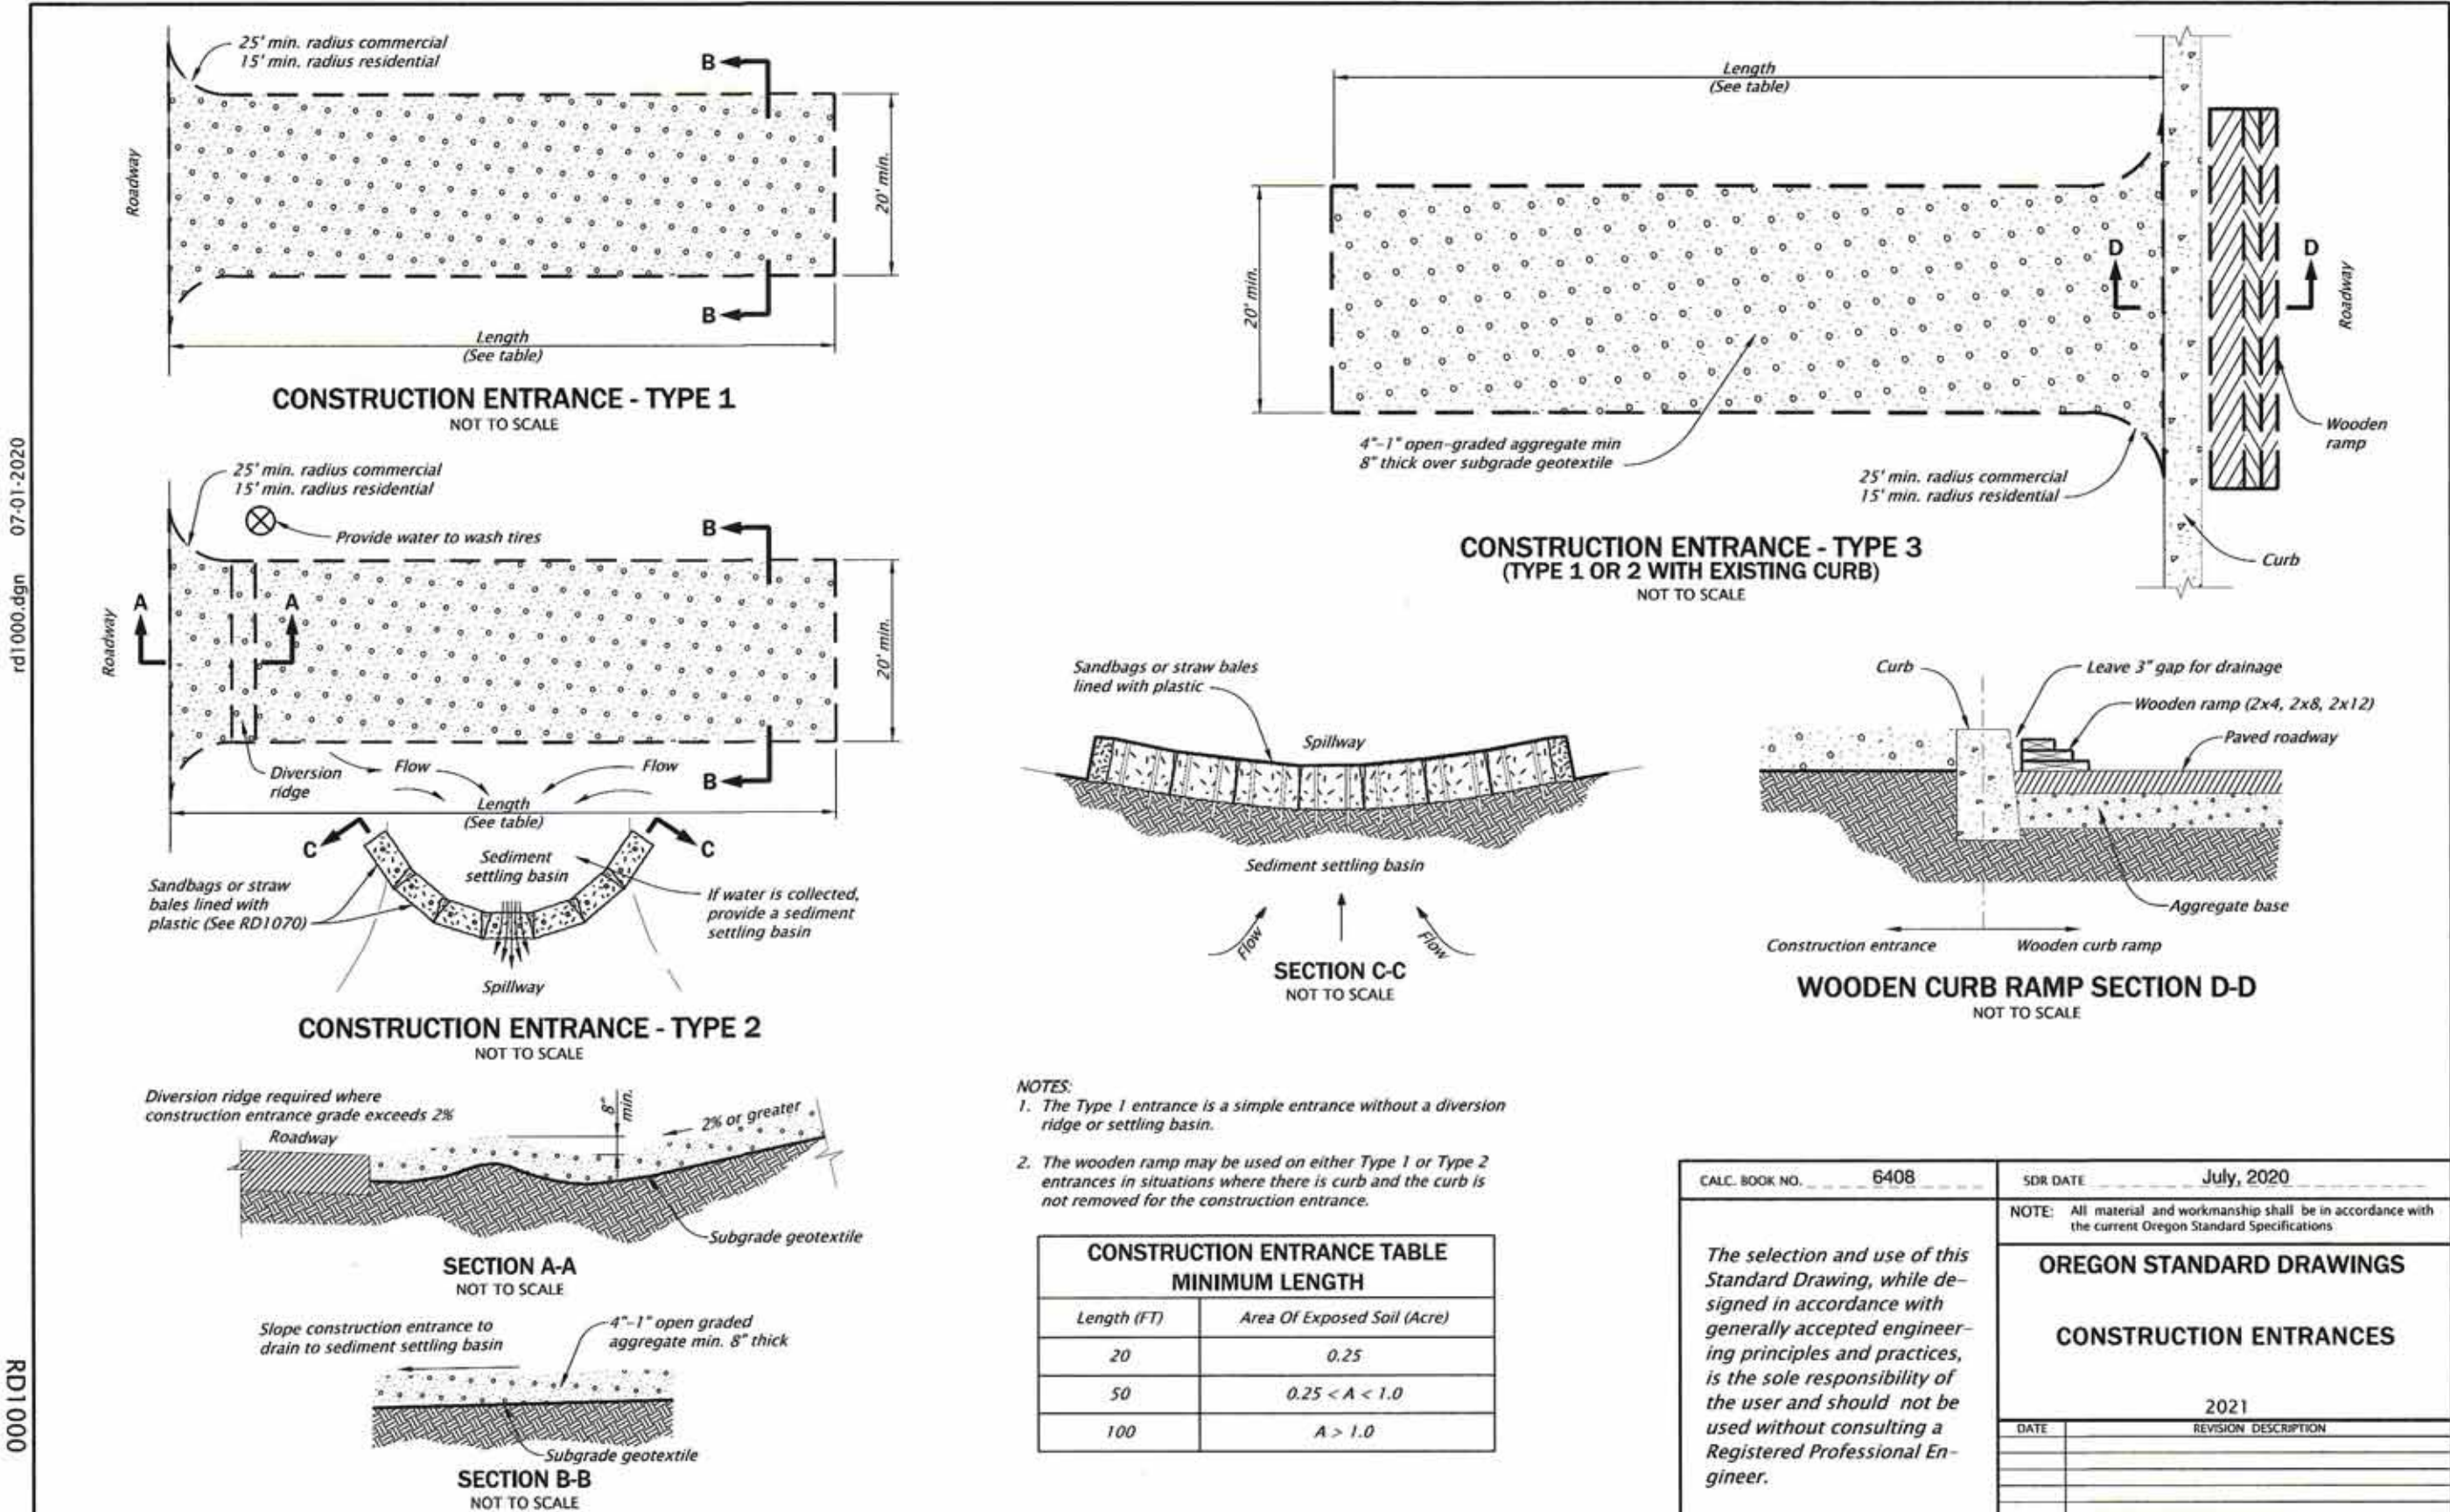

CALC. BOOK NO. 6408


DATE: July, 2020

OREGON STANDARD DRAWINGS

CONSTRUCTION ENTRANCES

DATE: 2021

REVISION DESCRIPTION:

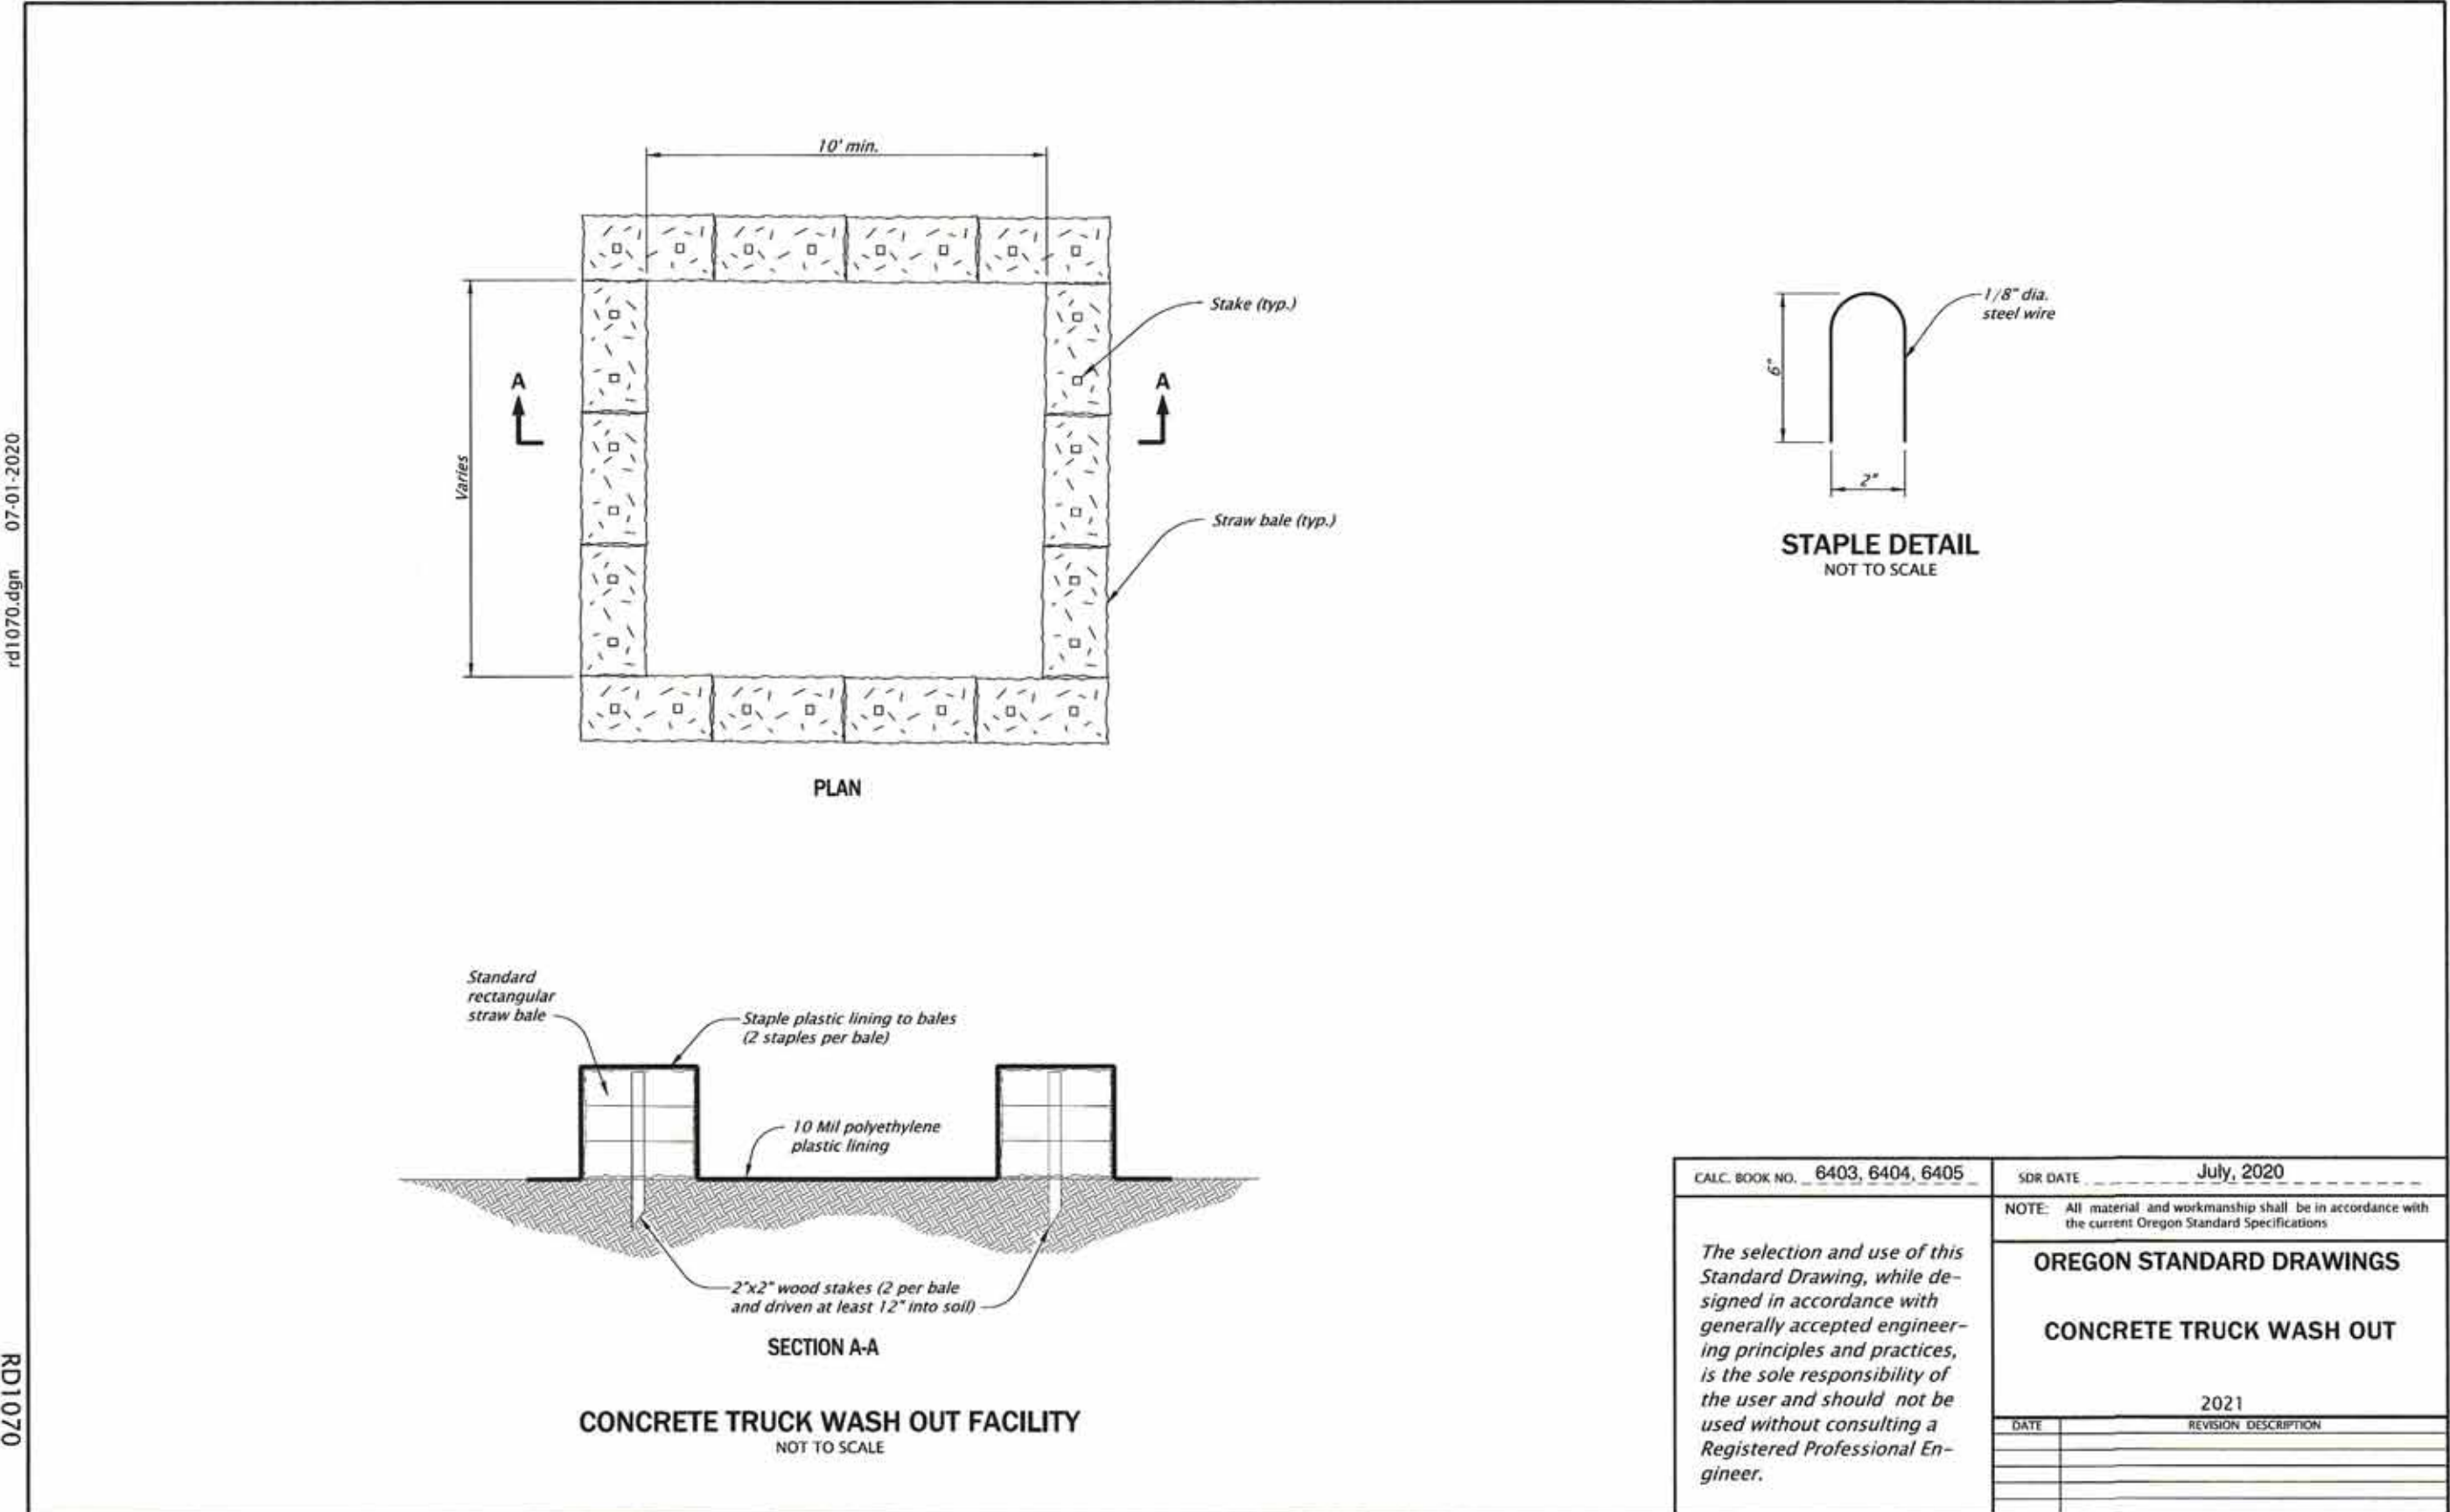

CALC. BOOK NO. 6403, 6404, 6405

DATE: July, 2020

OREGON STANDARD DRAWINGS

CONCRETE TRUCK WASH OUT

DATE: 2021

REVISION DESCRIPTION:



MYRTLE GLEN PUD

FINAL PUD IMPROVEMENT DRAWINGS

EROSION AND SEDIMENT CONTROL

STANDARD DRAWINGS AND DETAILS

FLORENCE, OREGON

| No | Description of Revisions | Date | Name |
|----|--------------------------|------|------|
| | | | |
| | | | |

| | | | |
|------------|-------------|------------|--------------|
| Date | 09-25-2023 | Job Number | 7091-22-0187 |
| Design by | C. BEECROFT | Drawn by | C. BEECROFT |
| Checked by | C. BEECROFT | | |